SPECIAL PERMIT & SITE DEVELOPMENT PLAN ''UNION SQUARE VILLAGE' WALPOLE, MASSACHUSETTS

DATE: JANUARY 24, 2024

ASSESSOR'S REFERENC MAP 20, PARCEL 119 MAP 20, PARCEL 136 MAP 20, PARCEL 137 MAP 20, PARCEL 115

PLAN REFERENCE:
PLAN No. 959 OF 1980, Bk. 5808, Pg. 530
PLAN No. 1520 OF 1987, BK. 362
PLAN No. 990 OF 1954, BK 3279, PG 340
PLAN FILED AS PG. 99, PL.BK. 672.

ZONING CLASSIFICATION:
GENERAL RESIDENCE — GR
30,000 S.F. (Three Family)
(10,000 S.F. each additional unit)
15—Units: 150,000 S.F.
FRONTAGE: 100 FT.

SETBACKS: FRONT: 30' SIDE: 10' REAR: 30' OWNERS OF RECORD:


1. MAP 20, PARCEL 119
DEED REF: BK. 34158, PG. 536
WALL STREET DEV. CORP.

P.O. BOX 272
WESTWOOD, MA 02090
2. MAP 20, PARCEL 136
DEED REF: BK. 36797, PG. 372
WALL STREET DEV. CORP.
P.O. BOX 272
WESTWOOD, MA 02090

3. MAP 20, PARCEL 137
DEED REF: BK. 37615, PG. 470
WALL STREET DEV. CORP/
P.O. BOX 272
WESTWOOD, MA 02090

4. MAP 20, PARCEL 115
DEED REF: BK. 25238, PG. 585
BRIAN MARTIN
7 BROOK LANE
WALPOLE, MA 02081

		•
	ZONING TABLE:	·
	REQUIRED	PROPOSED .
LOT AREA: (15 Units)	150,000 S.F.	157,373 S.F.
LOT FRONTAGE: YARD SETBACKS:	100 FT.	110.03 FT. (Brook Lane)
FRONT:	30 FT.	31.0 FT.(Brook Lane)
SIDE:	10 FT.	12.0 FT. 30.0 FT.
REAR:	30 FT.	30.0 F1.
LOT COVERAGE	30 %	15.5 %
STRUCTURES:	47,212 S.F.	24,344 S.F.
LOT COVERAGE	50 %	34.6 %
IMPERVIOUS:	78,686 S.F.	54,493
MAX BLDG HEIGHT:	35 FT.	35 FT.
MAX STORIES	2.5	2.5

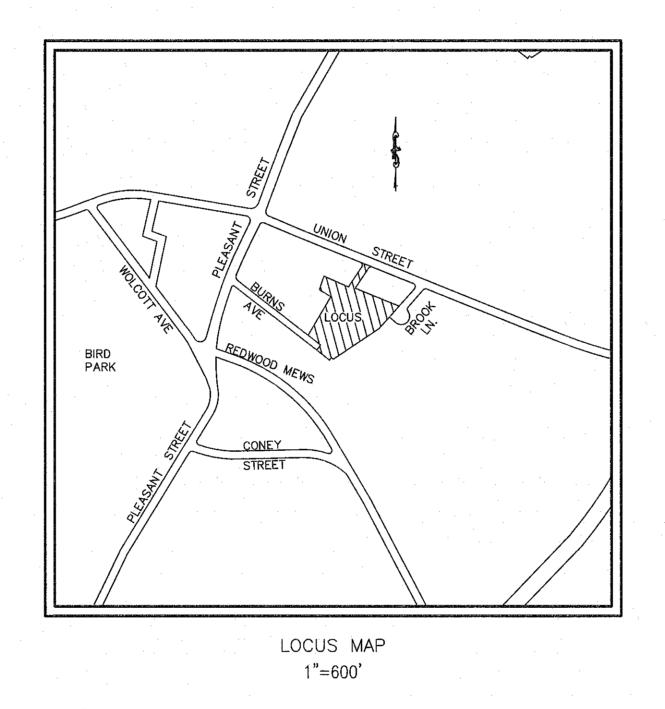

Prepared By:
GLM ENGINEERING
CONSULTANTS, INC.
19 EXCHANGE STREET
HOLLISTON, MASSACHUSETTS 01746
(508)429-1100 fax:(508)429-7160

Applicant:

WALL STREET DEVELOPMENT CORP.
P.O. BOX 272
WESTWOOD, MASSACHUSETTS 02090

DATE APPROVED:

DATE ENDORSED:

I TOWN CLERK OF THE TOWN OF WALPOLE RECEIVED & RECORDED FROM THE ZONING BOARD OF APPEALS, APPROVAL OF THIS PLAN


I TOWN CLERK OF THE TOWN OF WALPOLE RECEIVED & RECORDED FROM THE ZONING BOARD OF APPEALS, APPROVAL OF THIS PLAN AND NO APPEAL HAS BEEN TAKEN FOR TWENTY DAYS NEXT AFTER RECEIPT AND RECORDING OF SAME.

TOWN CLERK

APPROVED BY

ZONING BOARD OF APPEALS

DATE

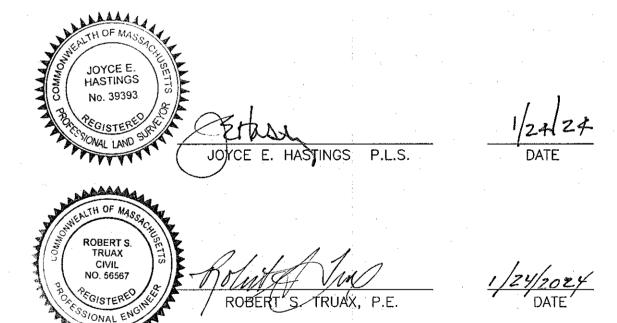

SHFFT	IND

- 1 COVER
- 2 EXISTING CONDTIONS
 3 LAYOUT PLAN
 4 GRADING, DRAINAGE & UTILITIES
- 5 PROFILES
- 6 EROSION CONTROL PLAN
 7-12 DETAILS
 SUP-A RIVERFRONT EXISTING CONDITIONS
 SUP-B RIVERFRONT AREA DISTURBANCE
 SUP-C RESTORATION AND PLANTING

JOB No.

15588

SCALE:


AS NOTED


DATE:


JANUARY 24, 2024


SHEET No.

1 of 13

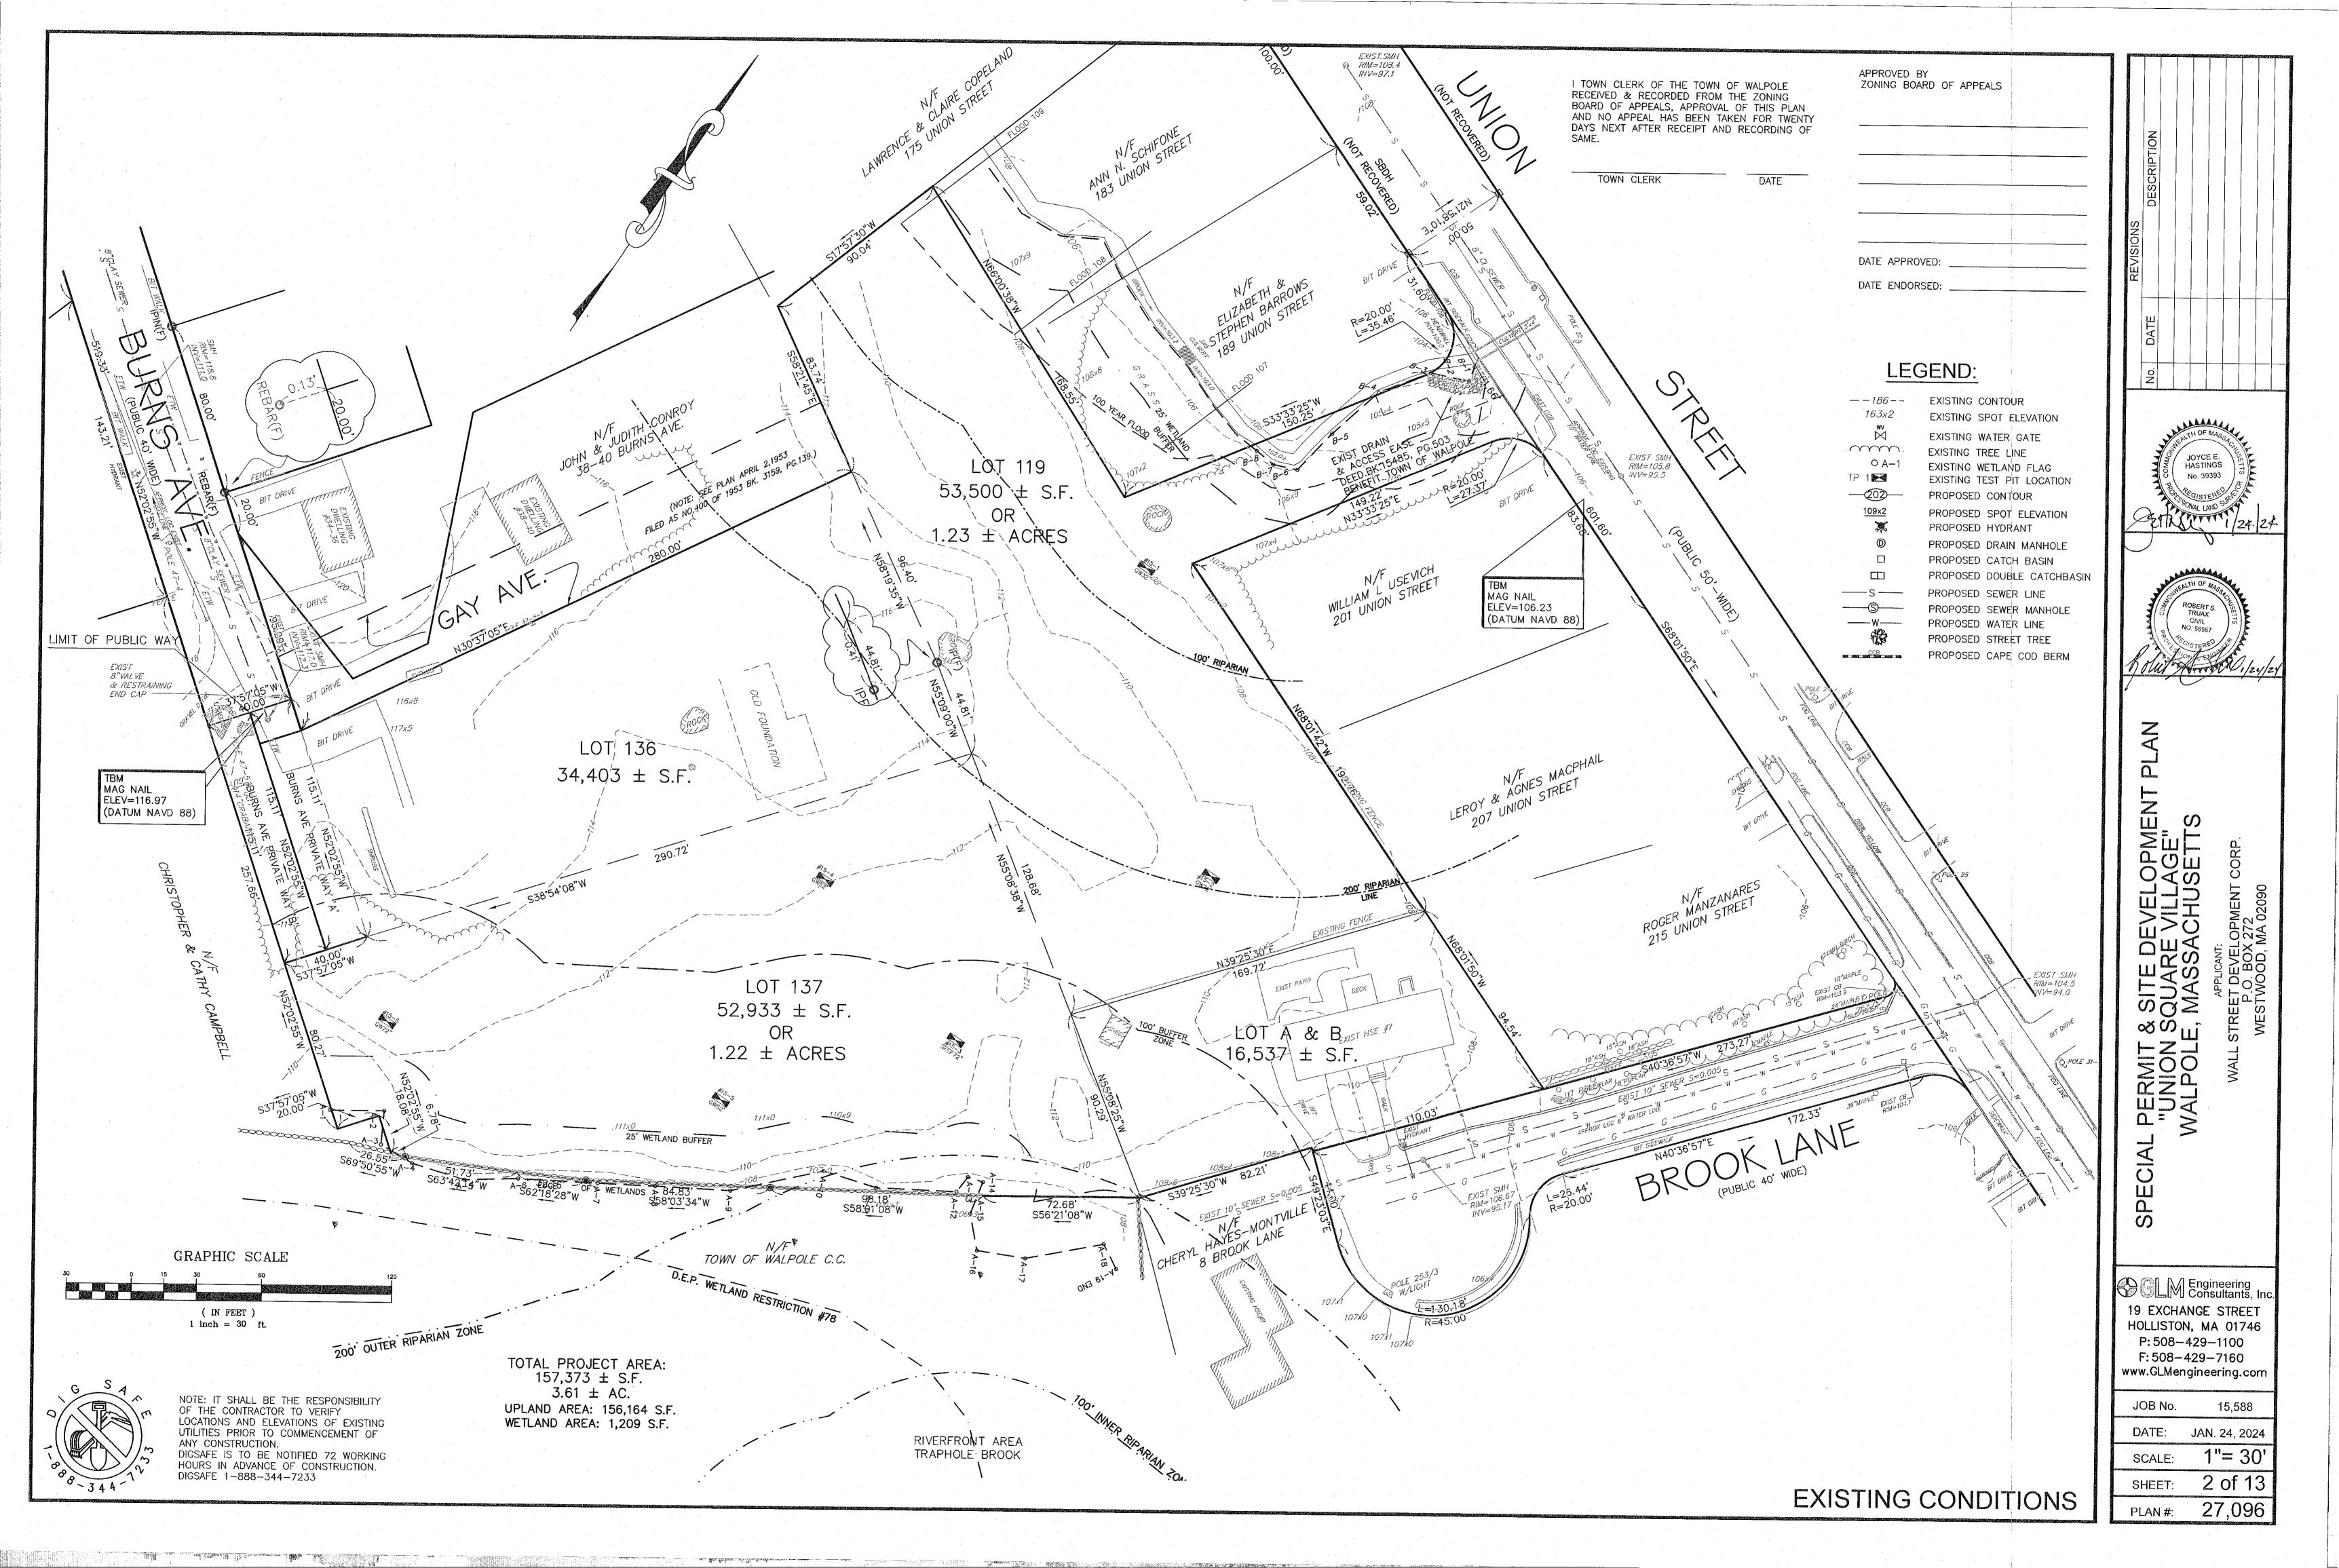


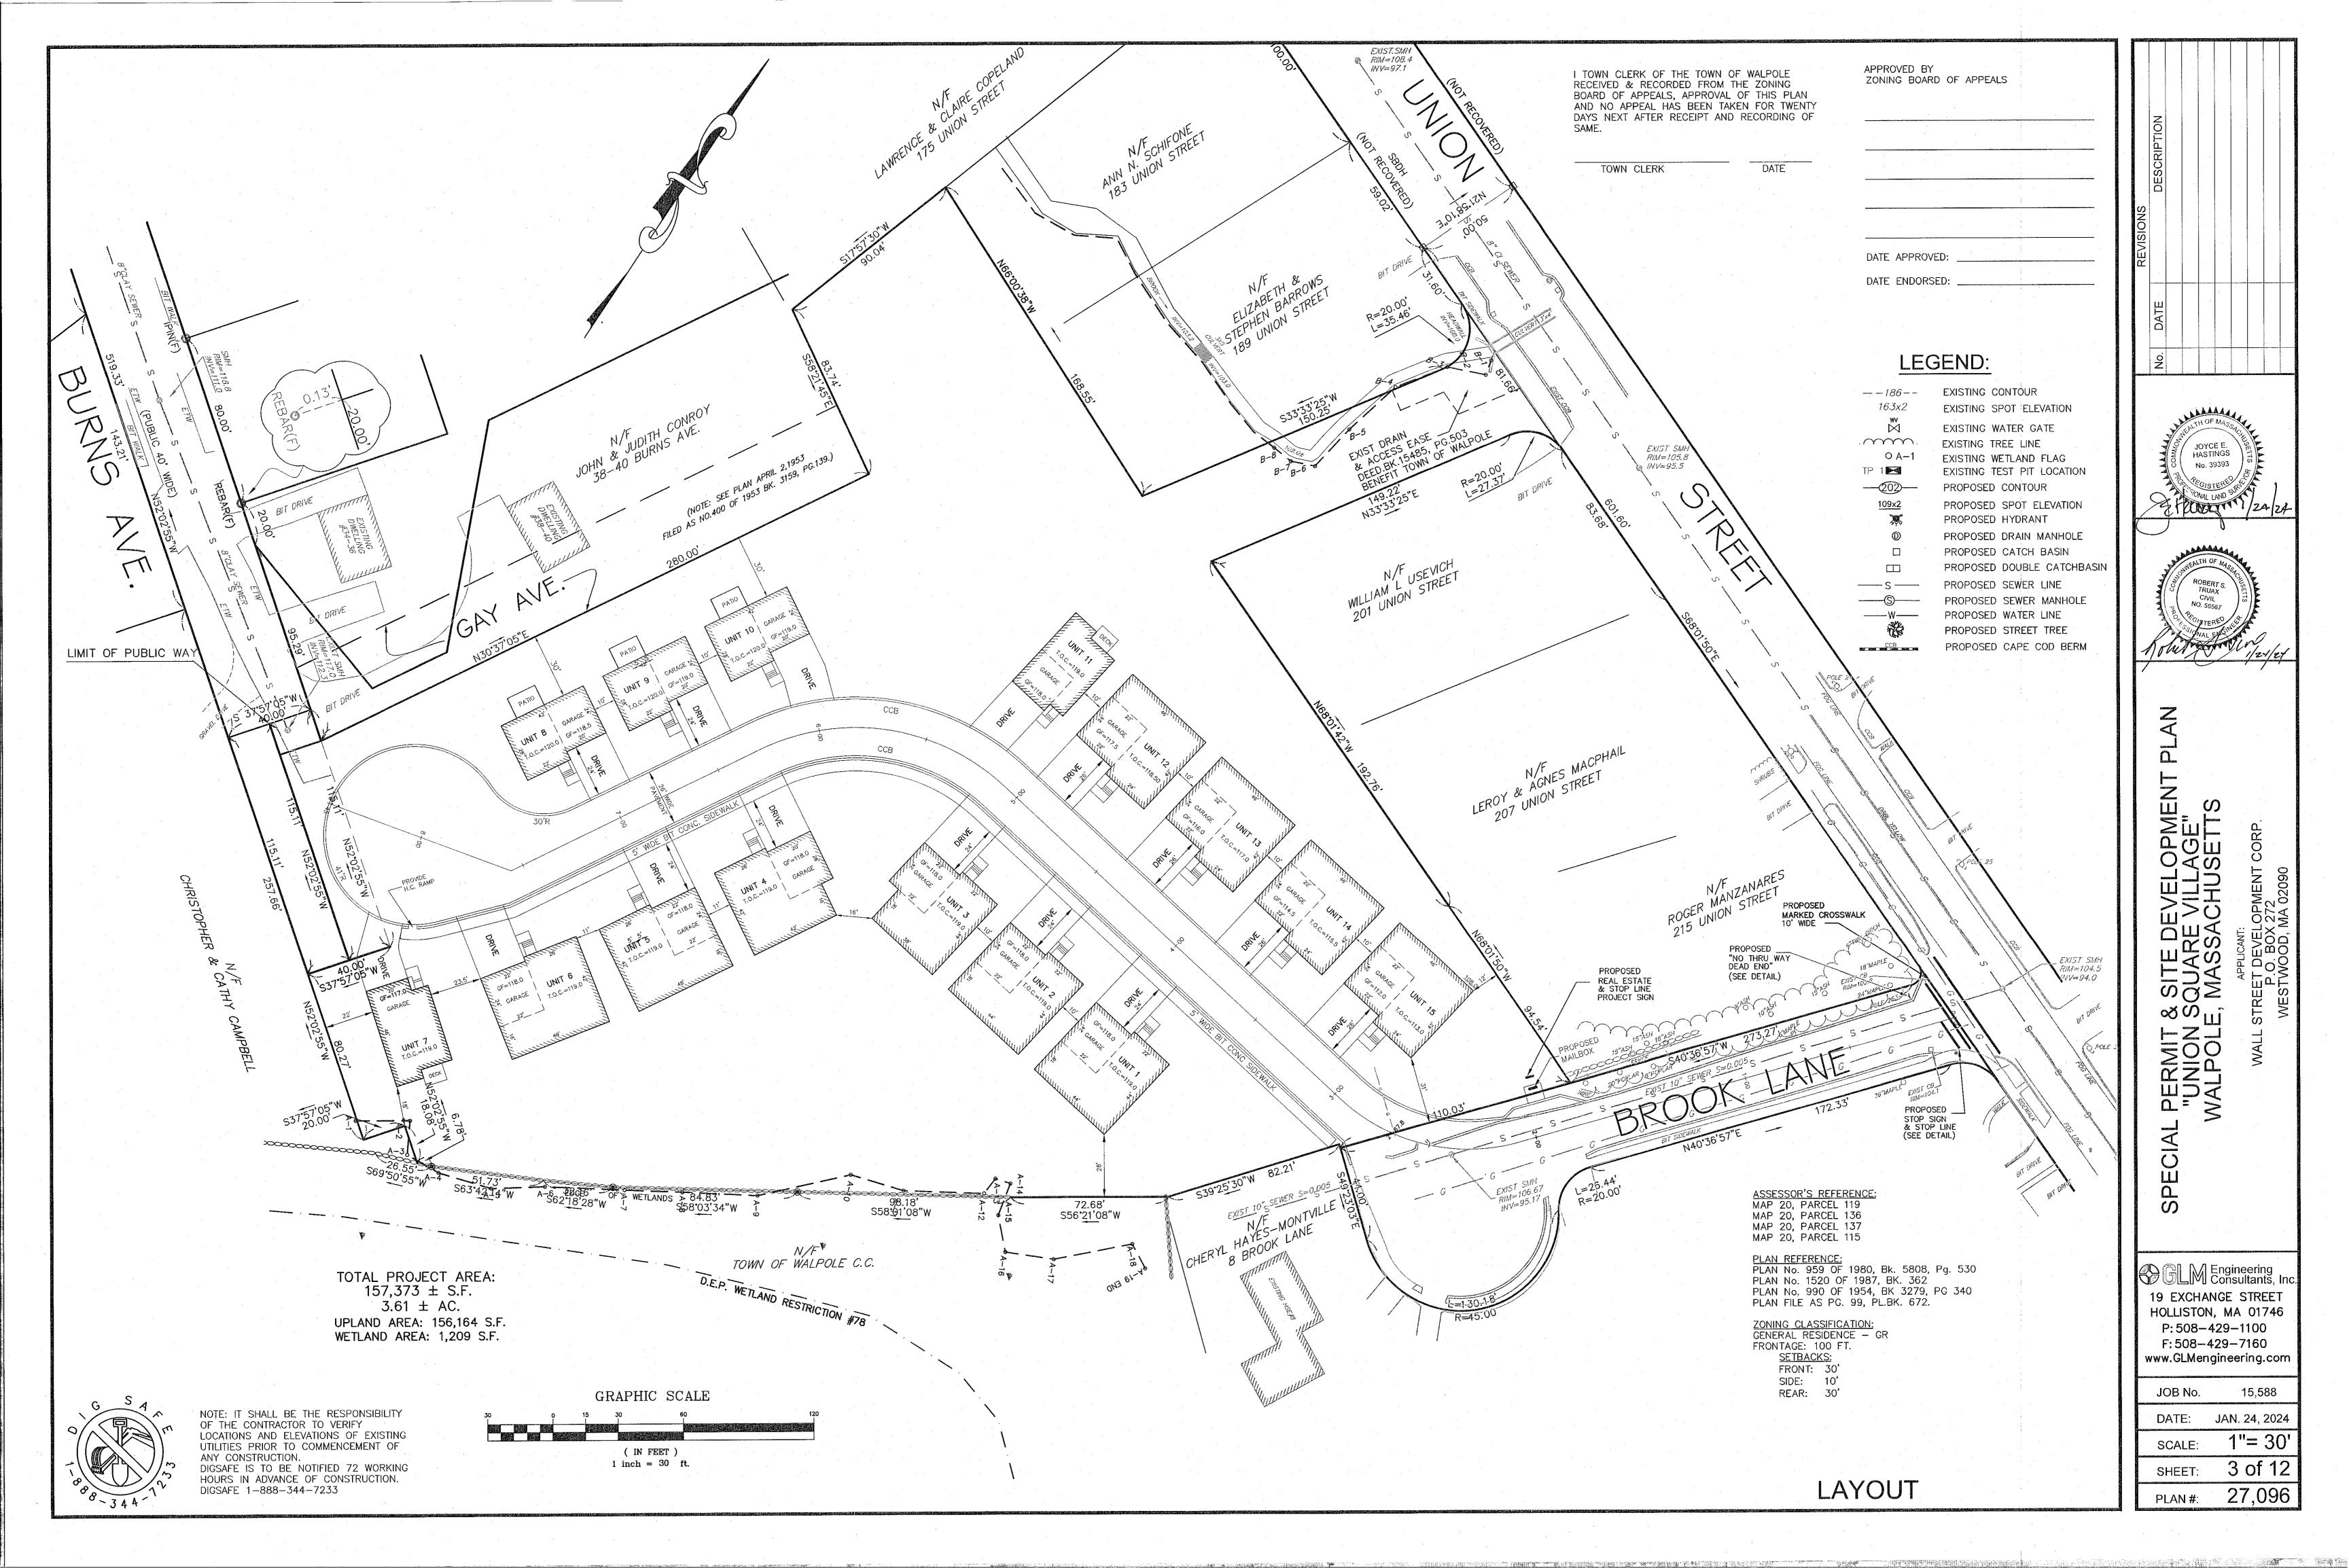

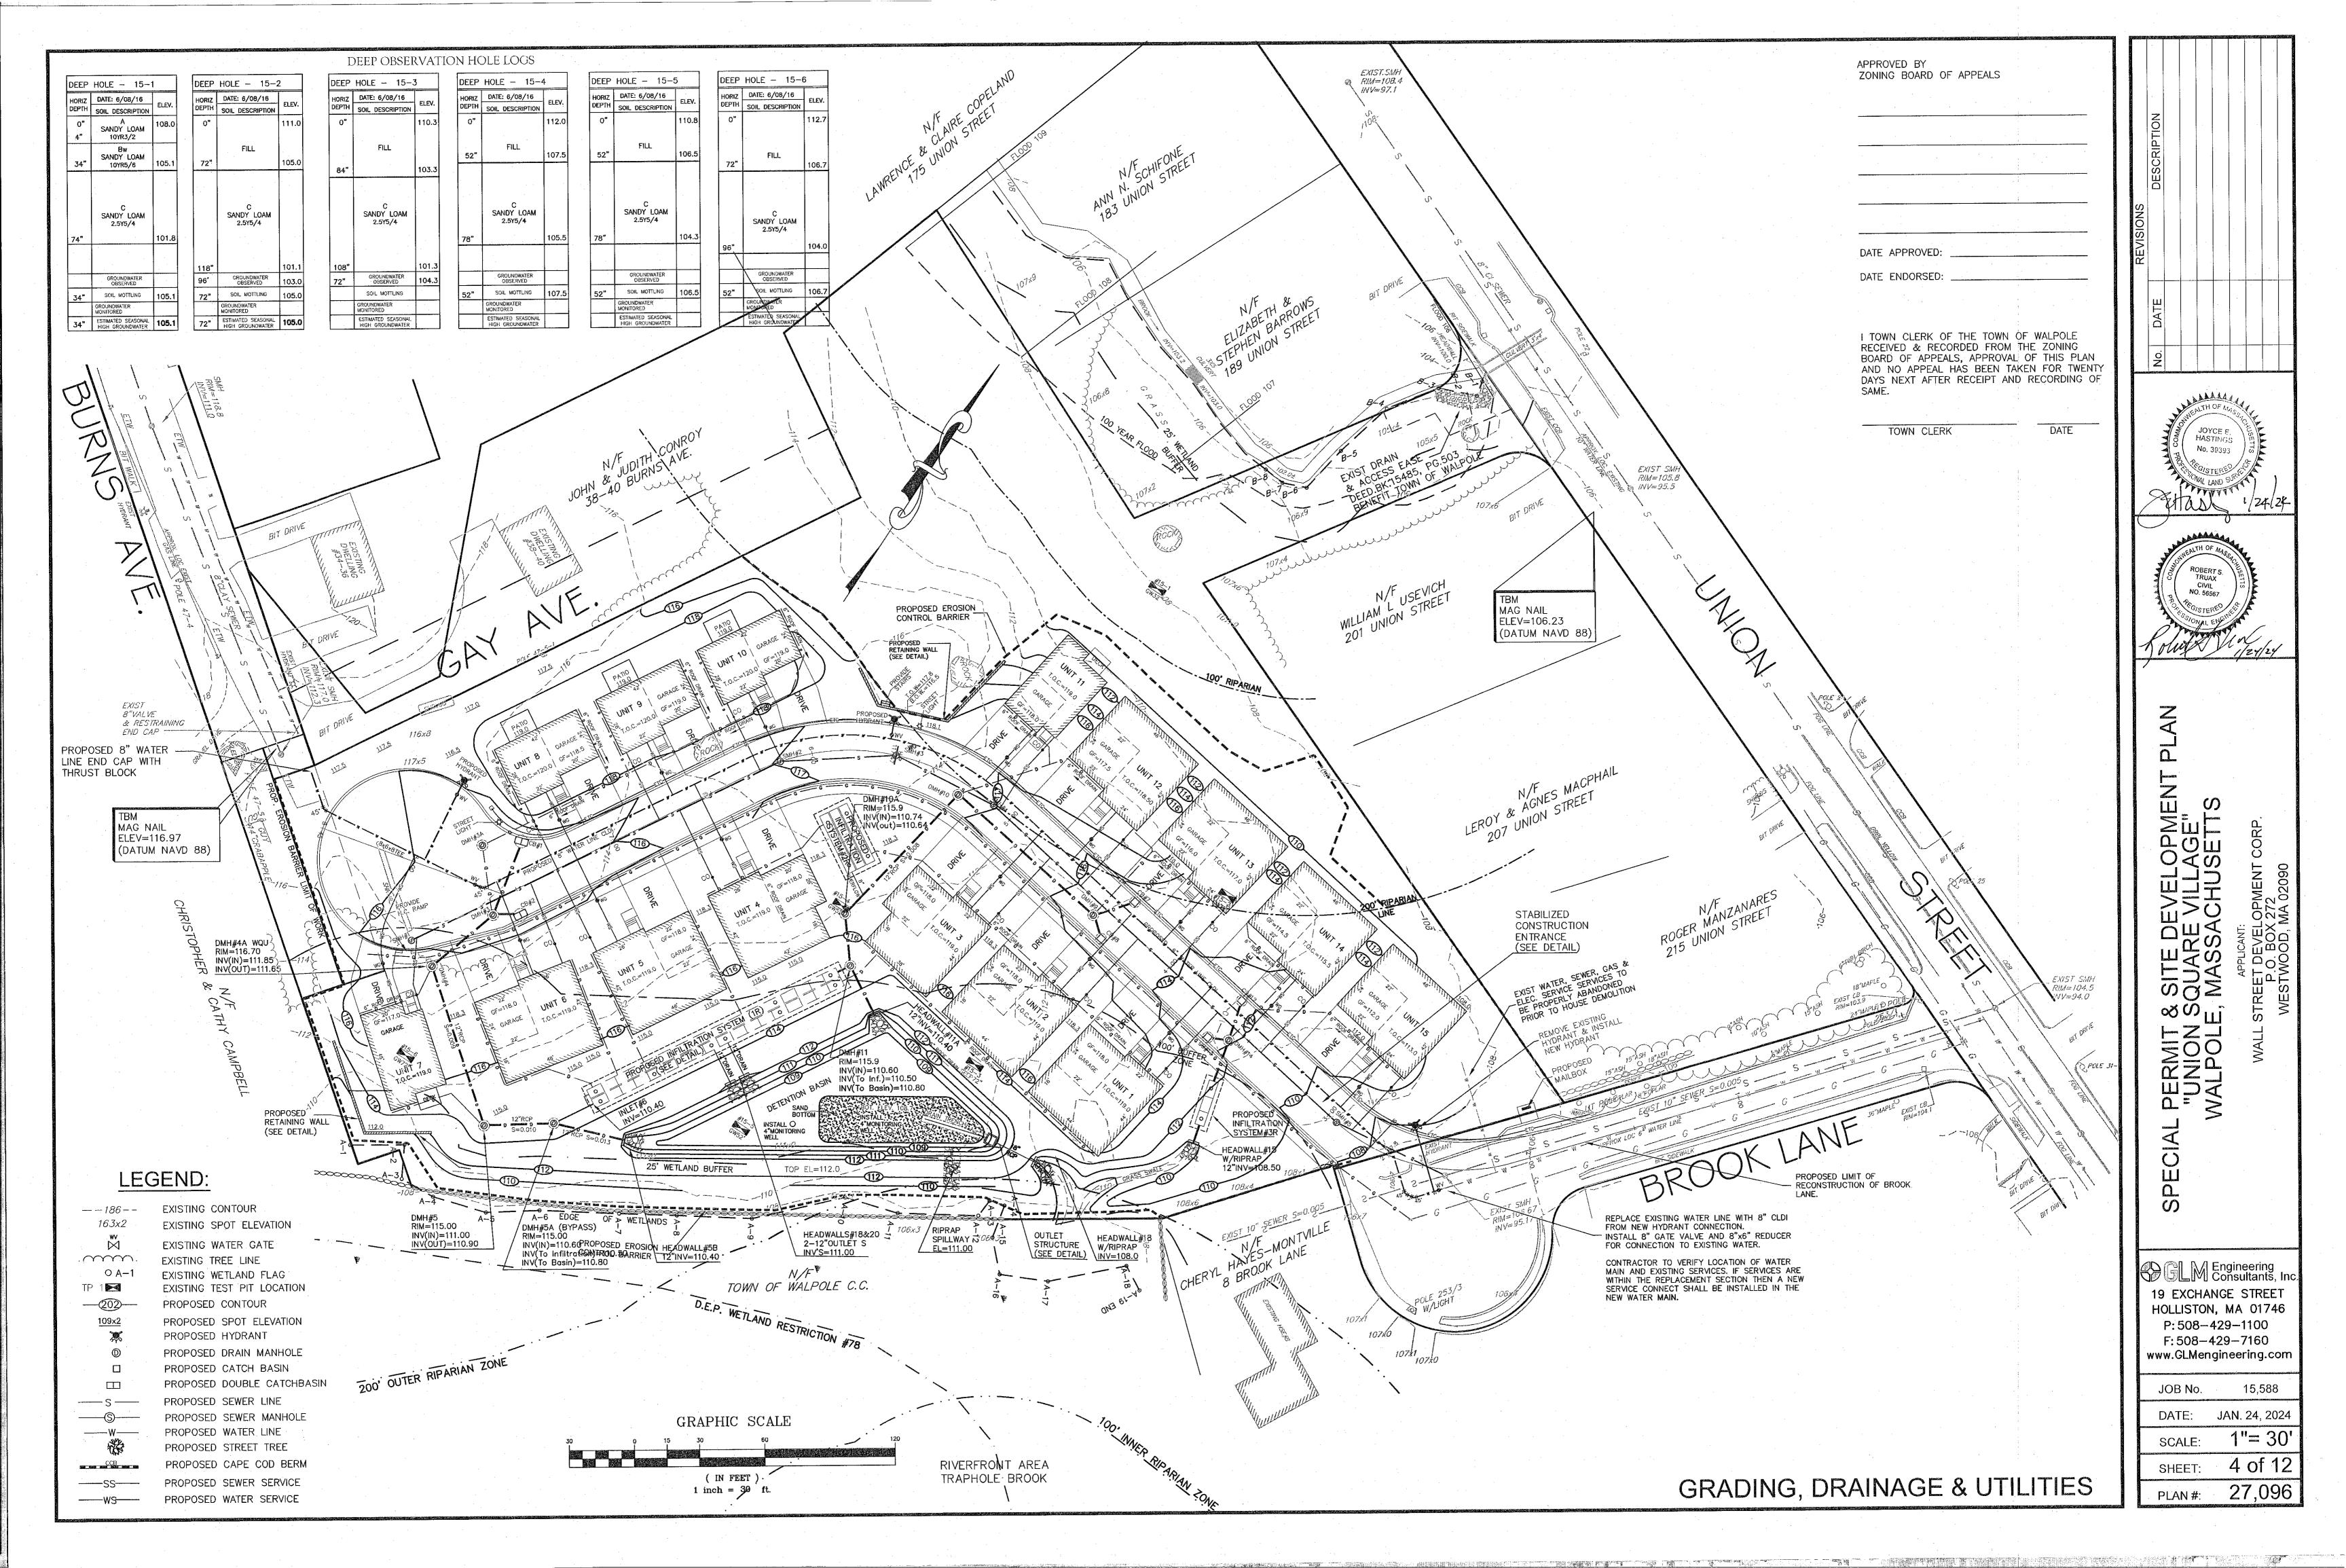


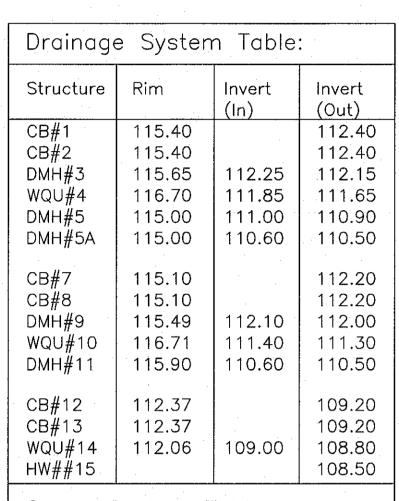


	Sewer S			
	Structure	Rim	Invert (In)	Invert (Out)
	SMH#1	116.00		108.50
	SMH#2	117.05	106.60	106.50
	SMH#3	117.47	105.97	105.87
	SMH#4	117.03	105.35	105.25
,	SMH#5	108.96	98.60	98.40
	EXIST#6	106.67	95.65	95.17
	,			

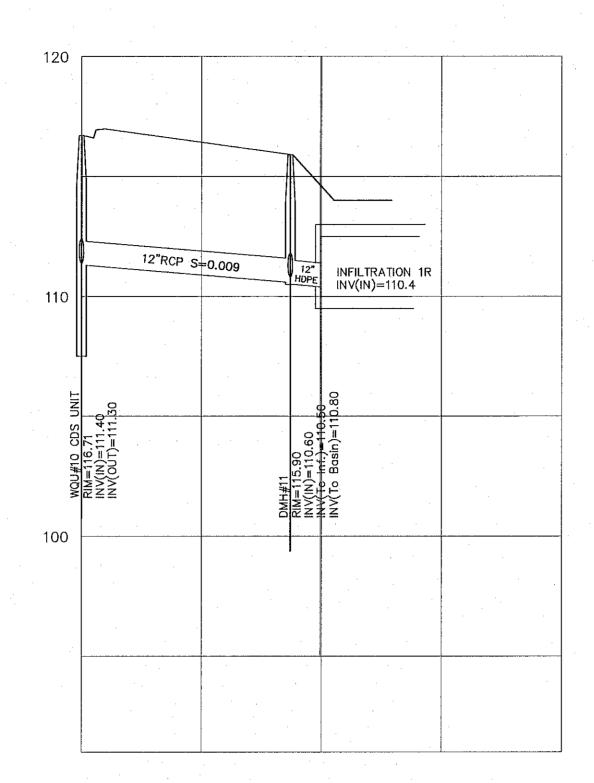

PROFILE DRAIN LINE DMH#10 TO HEADWALL#11A SCALE: Horiz: 1"=40'; Vert: 1"=4'

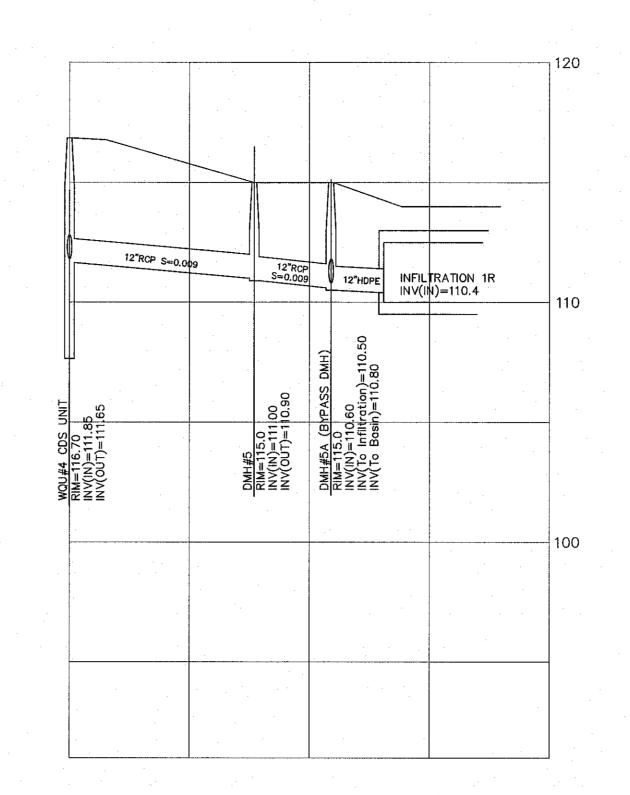

PROFILE DRAIN LINE DMH#4 TO HEADWALL#6 SCALE: Horiz: 1"=40'; Vert: 1"=4'

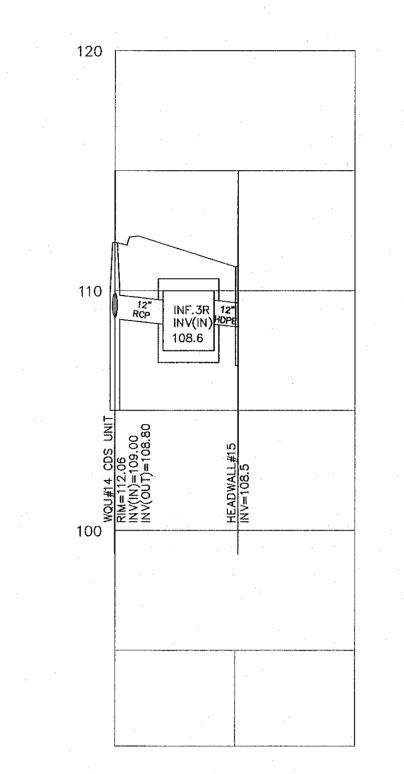

APPROVED BY

DATE ENDORSED:

TOWN CLERK

I TOWN CLERK OF THE TOWN OF WALPOLE RECEIVED & RECORDED FROM THE ZONING BOARD OF APPEALS, APPROVAL OF THIS PLAN

AND NO APPEAL HAS BEEN TAKEN FOR TWENTY


DAYS NEXT AFTER RECEIPT AND RECORDING OF

DATE

ZONING BOARD OF APPEALS

PROFILE DRAIN LINE DMH#14 TO HEADWALL#15


SCALE: Horiz: 1"=40'; Vert: 1"=4'

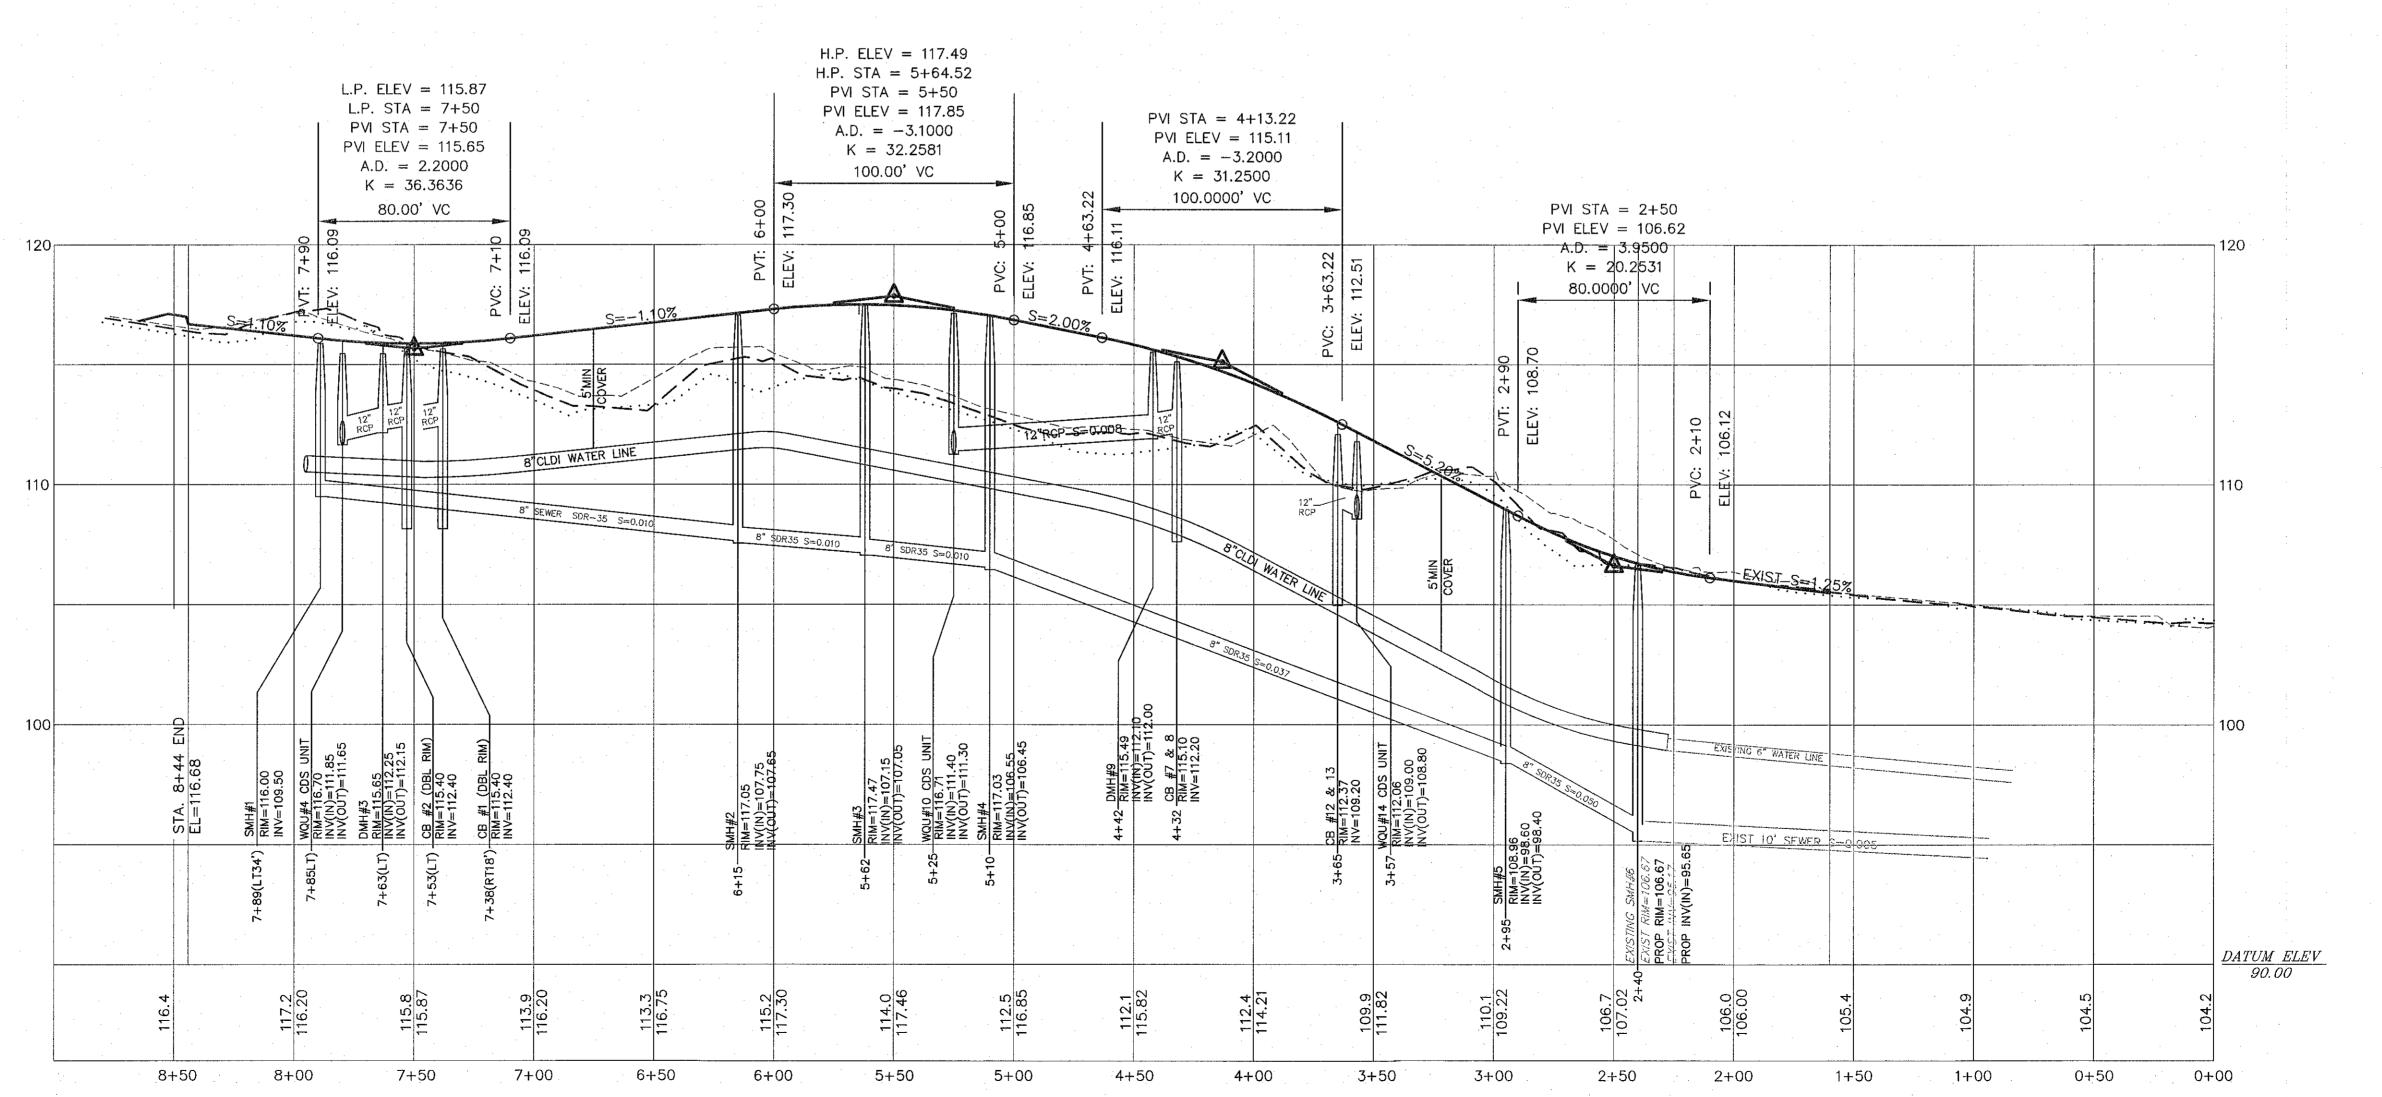

GRAPHIC SCALE (IN FEET) 1 inch = 30 ft.

PROFILE DRIVE 'A' SCALE: Horiz: 1"=40'; Vert: 1"=4'

PROFILE PLAN

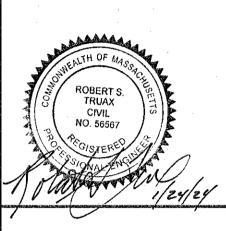



T & SITE DEVELOPMEN N SQUARE VILLAGE" LE, MASSACHUSETTS STREET DEVELOPMENT P.O. BOX 272 WESTWOOD, MA 02090 WALPOLE SPECIAL


BELM Engineering Consultants, Inc 19 EXCHANGE STREET HOLLISTON, MA 01746 P: 508-429-1100 F: 508-429-7160 www.GLMengineering.com

> JOB No. 15,588 DATE: JAN. 24, 2024 1"= 30' SCALE: 5 of 12


SHEET: 27,096 PLAN#:

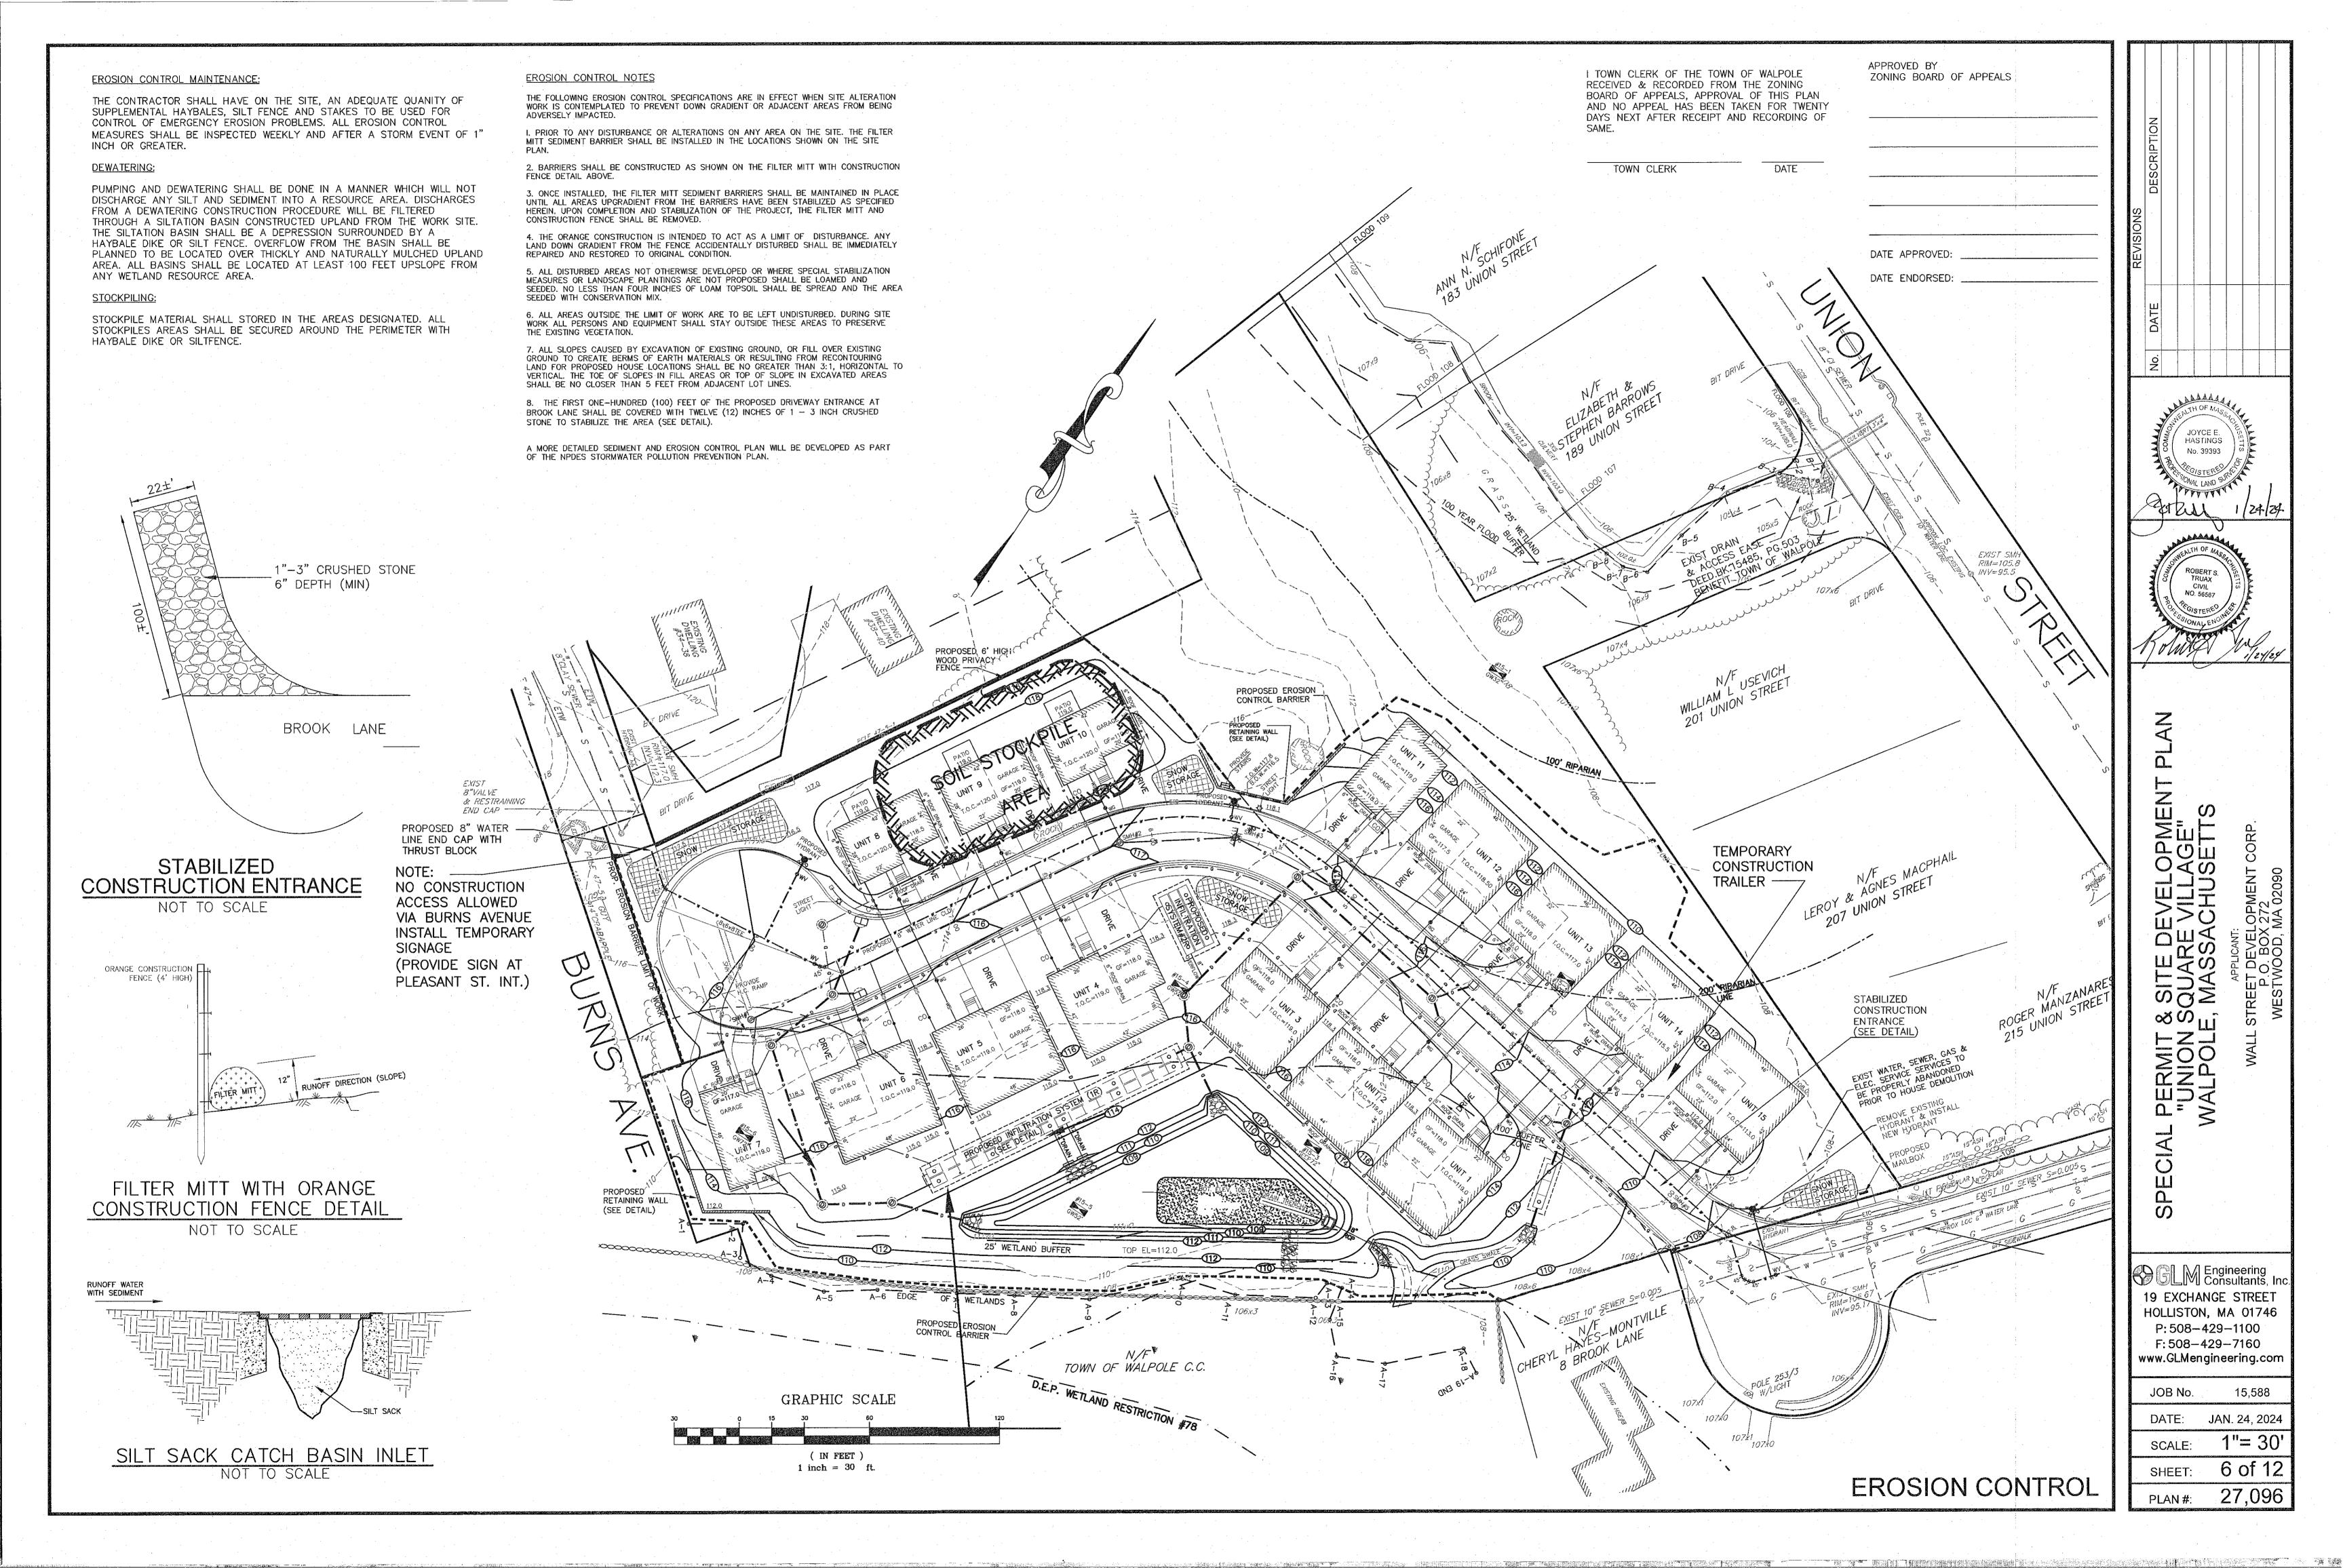

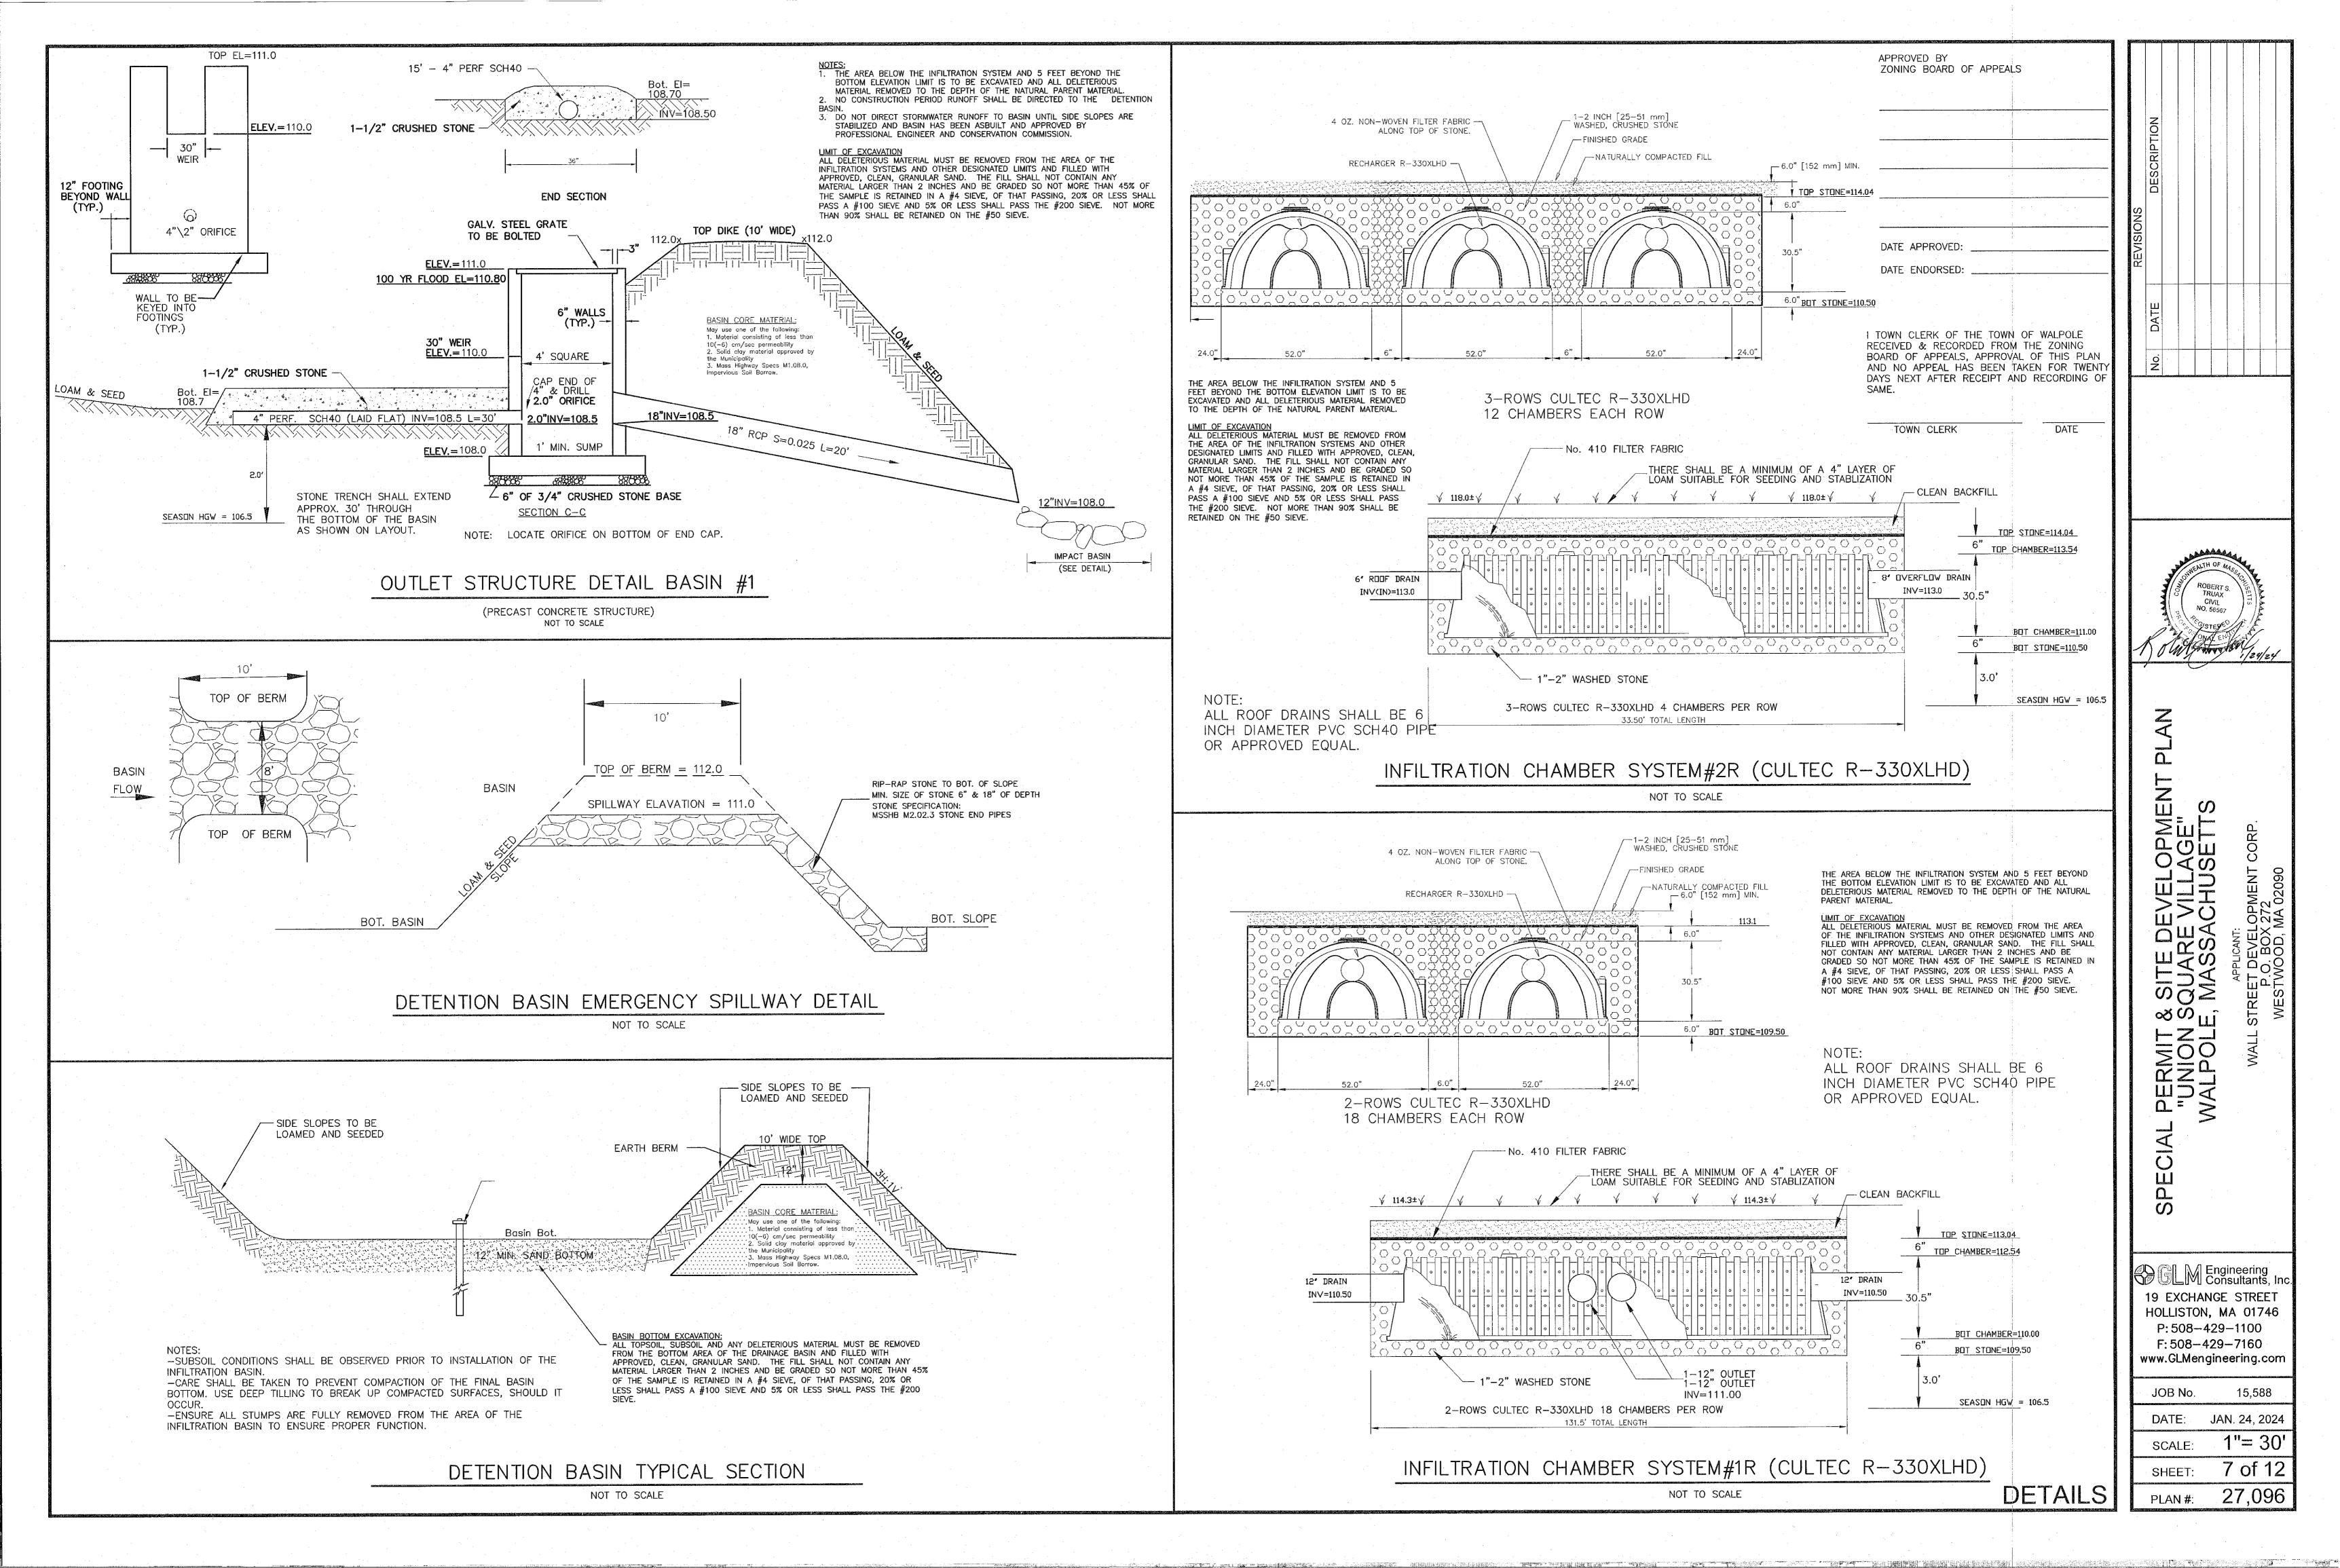

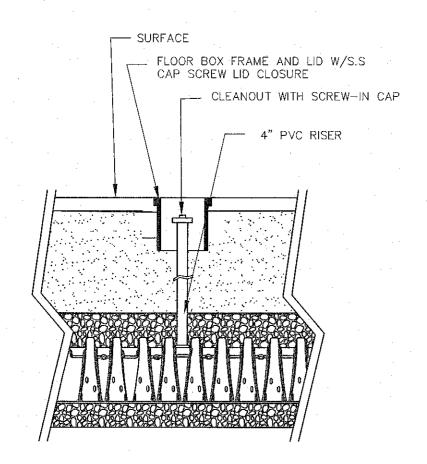


INSPECTION PORT DETAIL

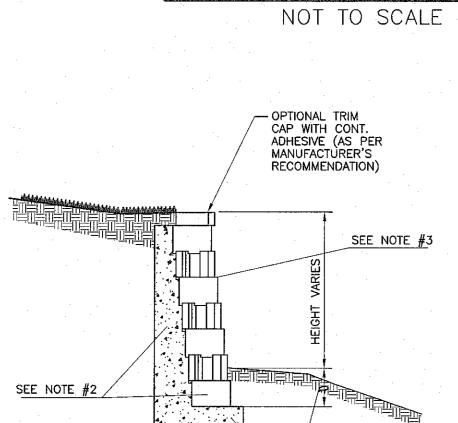

SEE NOTE #1


TYPICAL CROSS SECTION SCALE: NONE


-DIMENSIONS: 8"H x 12"D x 18"L -12' SETBACK FROM VERTICLE -TYPICAL WEIGHT = 75 lbs.

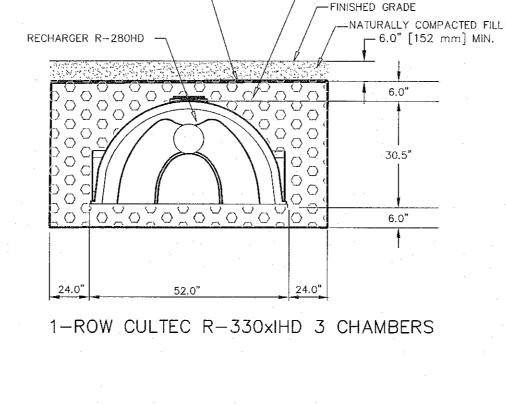

-1-2 INCH [25-51 mm] WASHED, CRUSHED STONE


4 OZ. NON-WOVEN FILTER FABRIC — ALONG TOP OF STONE.

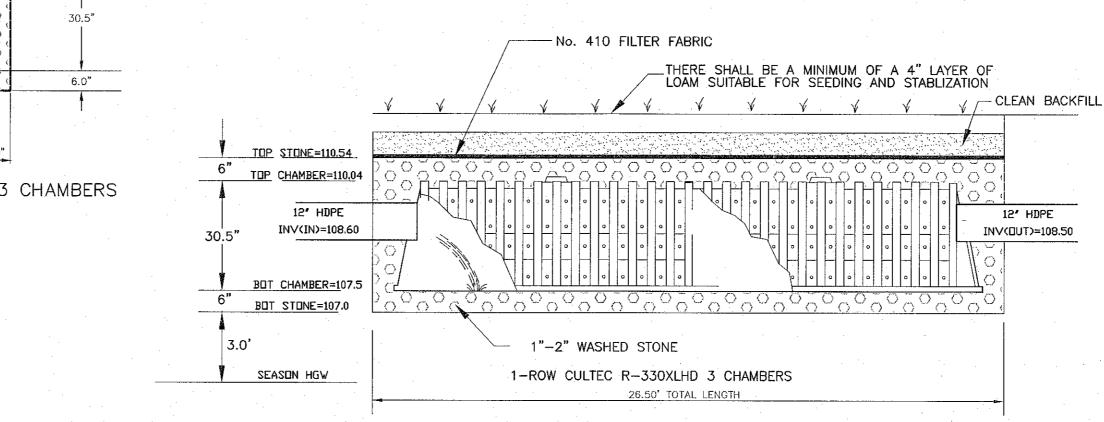

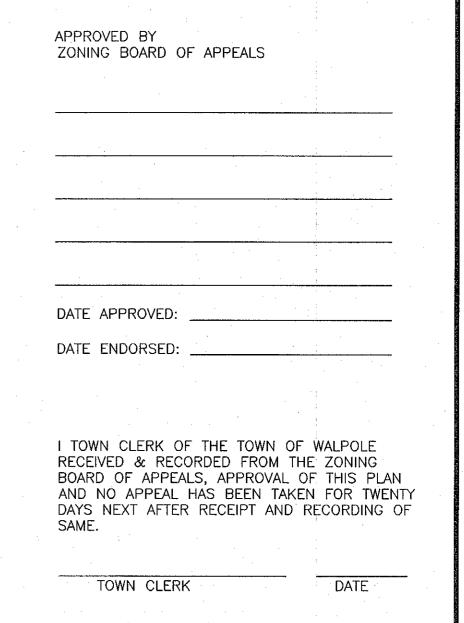

INFILTRATION CHAMBER SYSTEM#3R (CULTEC R-330XLHD)

NOT TO SCALE

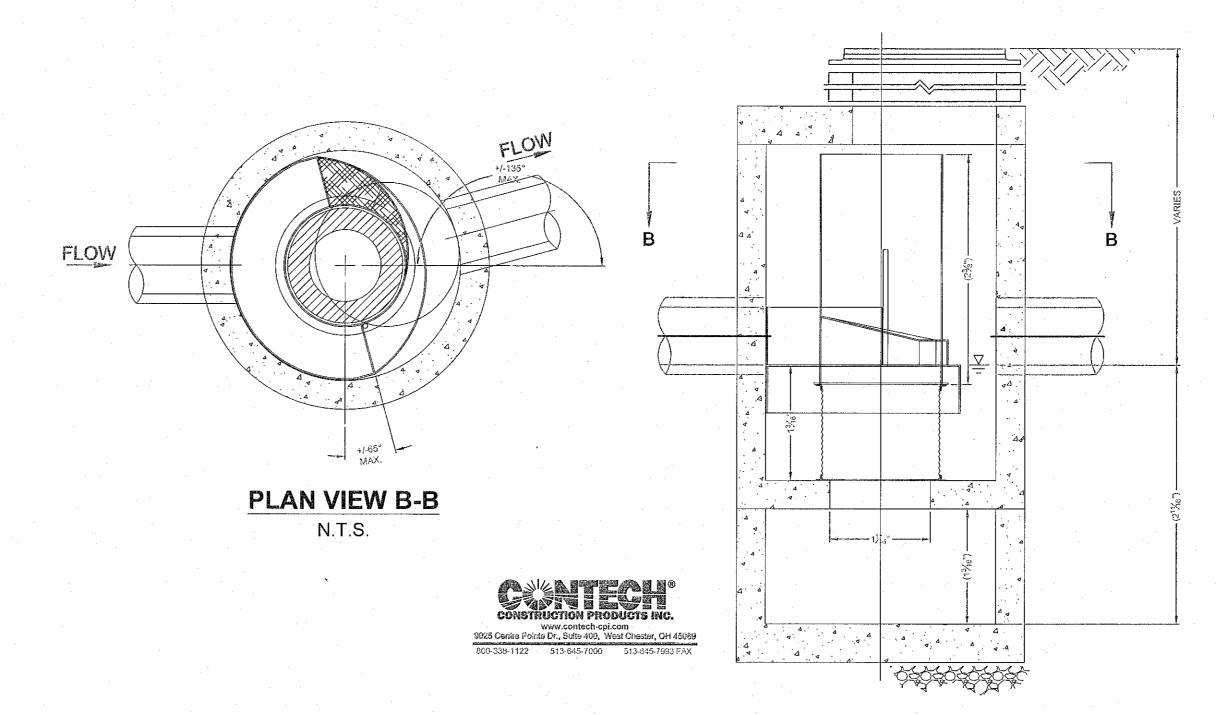

GENERAL NOTES

1. CONTECH TO PROVIDE ALL MATERIALS UNLESS NOTED OTHERWISE.

2. DIMENSIONS MARKED WITH () ARE REFERENCE DIMENSIONS. ACTUAL DIMENSIONS MAY VARY.

3. FOR FABRICATION DRAWINGS WITH DETAILED STRUCTURE DIMENSIONS AND WEIGHTS, PLEASE CONTACT YOUR CONTECH CONSTRUCTION PRODUCTS REPRESENTATIVE. WWw.contech-cpi.com

- 4. CDS WATER QUALITY STRUCTURE SHALL BE IN ACCORDANCE WITH ALL DESIGN DATA AND INFORMATION CONTAINED IN THIS DRAWING.

 5. STRUCTURE SHALL MEET AASHTO HS20 AND CASTINGS SHALL MEET AASHTO M306 LOAD RATING, ASSUMING GROUNDWATER ELEVATION AT, OR BELOW, THE OUTLET PIPE INVERT ELEVATION. ENGINEER OF RECORD TO CONFIRM ACTUAL GROUNDWATER
- 6. PVC HYDRAULIC SHEAR PLATE IS PLACED ON SHELF AT BOTTOM OF SCREEN CYLINDER. REMOVE AND REPLACE AS NECESSARY DURING MAINTENANCE CLEANING.
- ANY SUB-BASE, BACKFILL DEPTH, AND/OR ANTI-FLOTATION PROVISIONS ARE SITE-SPECIFIC DESIGN CONSIDERATIONS AND SHALL BE SPECIFIED BY ENGINEER OF RECORD.
 CONTRACTOR TO PROVIDE EQUIPMENT WITH SUFFICIENT LIFTING AND REACH CAPACITY TO LIFT AND SET THE CDS MANHOLE. CONTRACTOR TO PROVIDE EQUIPMENT WITH SUFFICIENT LIFTING AND REACH CAPACITY TO LIFT AND SET THE GDS MAGNIGUES.
 STRUCTURE (LIFTING CLUTCHES PROVIDED).
 CONTRACTOR TO ADD JOINT SEALANT BETWEEN ALL STRUCTURE SECTIONS, AND ASSEMBLE STRUCTURE.
 CONTRACTOR TO PROVIDE, INSTALL, AND GROUT PIPES. MATCH PIPE INVERTS WITH ELEVATIONS SHOWN.
 CONTRACTOR TO TAKE APPROPRIATE MEASURES TO ASSURE UNIT IS WATER TIGHT, HOLDING WATER TO FLOWLINE INVERT MINIMUM. IT IS SUGGESTED THAT ALL JOINTS BELOW PIPE INVERTS ARE GROUTED.

WATER QUALITY UNIT DETAIL CDS1515-3-C CDS INLINE STANDARD DETAIL

NOT TO SCALE

ELEVATION A-A

N.T.S.

SCHATECH

FRAME AND COVER (DIAMETER VARIES) N.T.S.

T & SITE DEVELOPME N SQUARE VILLAGE" LE, MASSACHUSETTS WALPOLE CA

Ū

S


BGLM Engineering Consultants, Inc 19 EXCHANGE STREET HOLLISTON, MA 01746 P: 508-429-1100 F: 508-429-7160 www.GLMengineering.com

JOB No.

DATE:	JAN. 24, 2024
SCALE:	1"= 30
SHEET:	8 of 13
PLAN#:	27,096

15,588

ALLAN BLOCK RETAINING WALL OR APPROVED EQUAL NOT TO SCALE

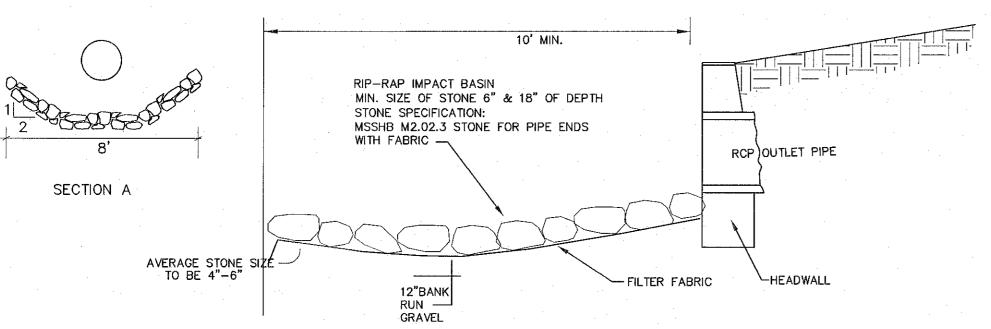

RIP-RAP DETAIL HEADWALLS NOT TO SCALE

RETAINING WALL NOTES:

#1 - BASE TRENCH & BASE MATERIAL

INSTEAD OF USING BASE MATERIAL.

#2 - BASE COARSE AND DRAINAGE MATERIAL

TRENCH TO BE 18" WIDE AND MUST INCLUDE THE REMOVAL OF ANY ORGANIC/FILL MATERIAL. BASE MATERIAL IS ANY CLEAN, COMPACTIBLE GRANULAR MATERIAL 1/4"-3/4" DIAMETER. PLACE

COMPACT WITH A MECHANICAL PLATE COMPACTOR. BASE MUST BE LEVEL. A THIN LAYER OF SAND MAY BE USED TO MAKE LEVELING EASIER. A CONCRETE LEVELING PAD MAY BE USED

LAY BASE COARSE BLOCKS CHECKING FOR STRAIGHTNESS AND LEVEL. FILL THE BLOCK HOLLOW CORES AND 6"-8" BEHIND

BLOCKS WITH DRAINAGE MATERIAL (SAME AS BASE MATERIAL). USE A PLATE COMPACTOR TO COMPACT THE AGGREGATE IN THE BLOCKS AND BEHIND THE WALL. RUN COMPACTOR OVER TOP

OF BLOCKS FIRST, AND THEN OVER DRAINAGE MATERIAL.


STACK NEXT ROW OF BLOCKS, AND EACH ADDITIONAL ROW,

STRAIGHTNESS & LEVEL. FILL HLLOW CORES AND 6"-8" BEHIND BLOCKS WITH DRAINAGE MATERIAL AND COMPACT.

WITH SEAMS OFFSET FROM THE BLOCKS BELOW. CHECK FOR

#3 - SECOND COARSE AND ADDITIONAL COARSES

AT LEAST 12" OF BASE MATERIAL IN THE TRENCH AND

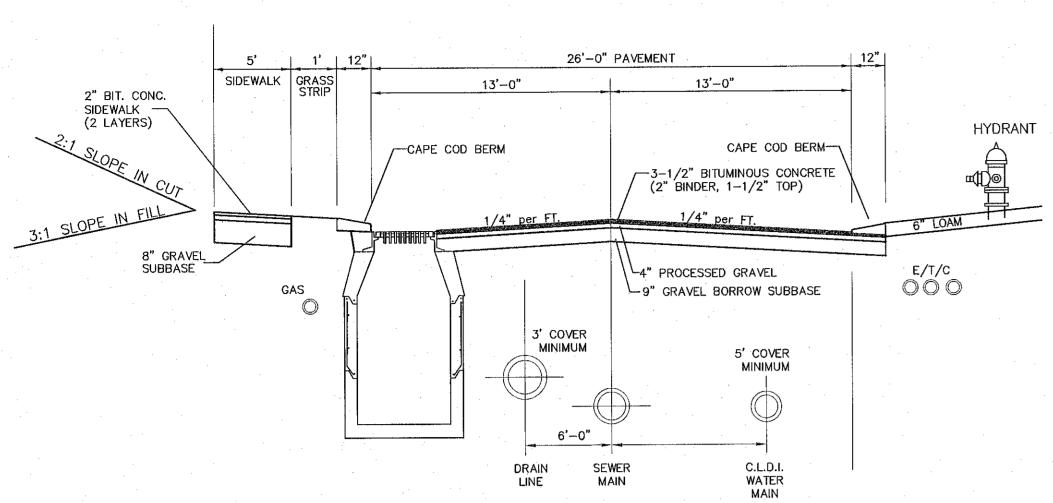


TYPICAL CROSS SECTION

(NO SCALE)

NOTE

- A). GRAVEL BORROW SUBBASE SHALL CONFORM TO SECTION M1.03.0 TYPE B, THREE INCHES LARGEST DIMENSION OF THE LATEST EDITION OF THE MASSACHUSETTS HIGHWAY DEPARTMENT STANDARD SPECIFICATIONS FOR HIGHWAYS AND BRIDGES (STANDARD SPECIFICATIONS).
- B). GRAVEL BORROW SUBBASE SHALL BE COMPACTED TO NOT LESS THAN 95 PERCENT OF MAXIMUM DRY DENSITY OF THE MATERIAL AS DETERMINED BY THE STANDARD AASHTO TEST DESIGNATION T99 COMPACTION TEST METHOD C AT OPTIMUM MOISTURE CONTENT AS DETERMINED BY THE ENGINEER.
- C). "TAC COAT" AS SPECIFIED IN SECTION 486.61 OF THE STANDARD SPECIFICATIONS SHALL BE APPLIED BY "TAC TRUCK" BETWEEN ASPHALT LAYERS OR AS DETERMINED BY THE ENGINEER.
- D). SOILS TESTING INCLUDING SIEVE ANALYSIS, PROCTOR TESTING AND COMPACTION TESTING SHALL BE PREFORMED ONCE EVERY 100 FEET OF PAVED ROADWAY ALONG THE CENTERLINE OF THE ROADWAY OR AS DIRECTED BY THE ENGINEER.
- E). SIDEWALK RAMPS MUST MEET CURRENT APPLICABLE ADA / AAB STANDARDS.

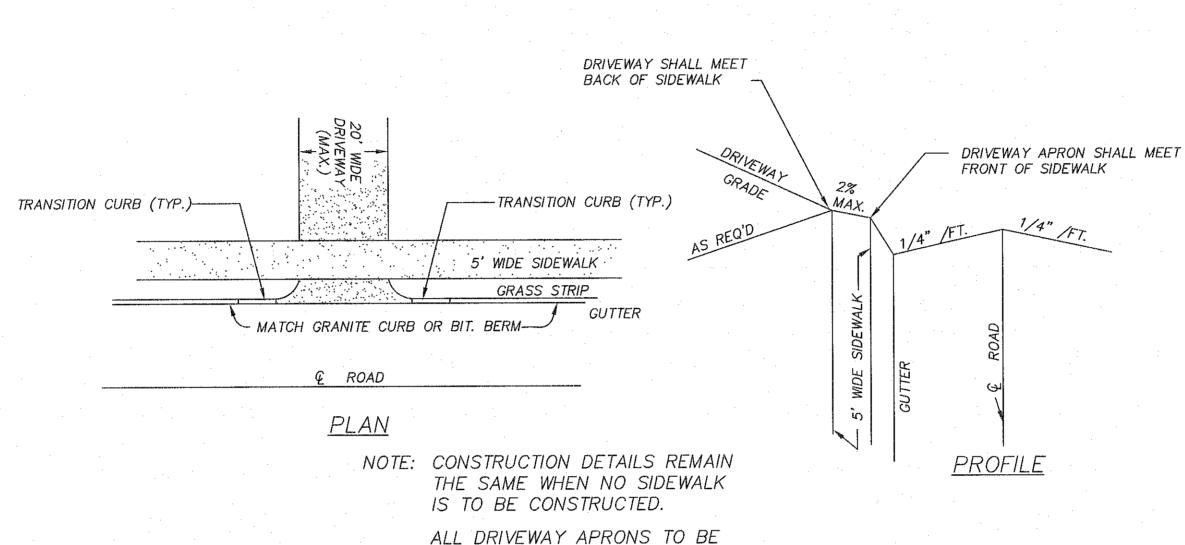

TYPICAL STREET SIGN NAME PLATE DETAIL

MINIMUM SIZE 9"

FILM OR APPROVED EQUAL

FOR RETROREFLECTIVITY.

4. FONT = HIGHWAY SERIES B

2. SIGN MATERIAL SHALL BE 3M VIP DIAG. GRADE

WHITE WITH BLUE TRANSLUCENT 3M-ELECTRO-CUT

3. SIGN MATERIAL MUST MEET THE LATEST FHWA RULES

5. FIRST LETTER OF EACH WORD IS TO BE UPPERCASE.


6" UPPERCASE, 4 1/2" LOWERCASE

AVERY DENNISON PRISMATIC LETTERS

TYPICAL MINOR DRIVEWAY DETAIL


PAVED WITH 3" BITUMINOUS CONCRETE

(NO SCALE)

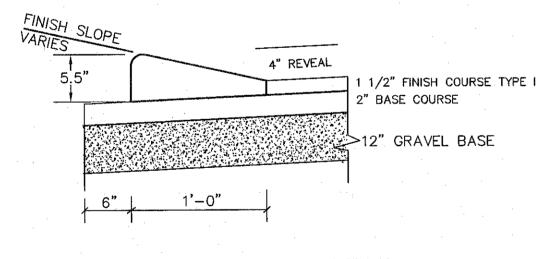


CAPE COD BERM DETAIL

NOT TO SCALE

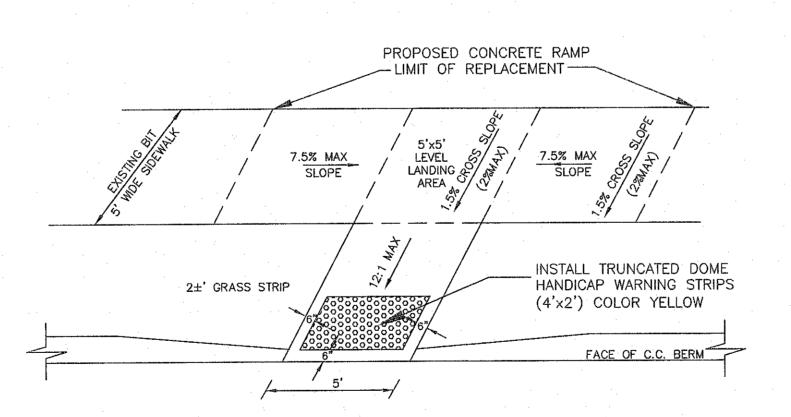

HANDICAP SIDEWALK RAMP DETAIL

(NO SCALE)

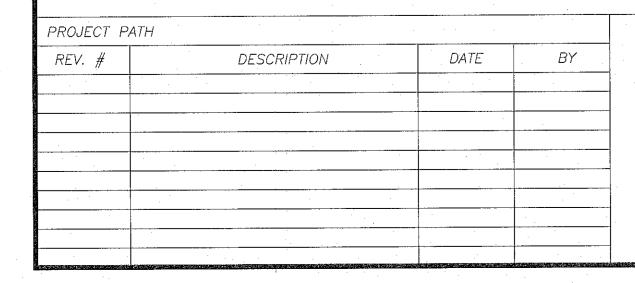


TOWN OF WALPOLE, MASSACHUSETTS
DEPARTMENT OF PUBLIC WORKS
PLAN SHOWING TYPICAL
ROADWAY DETAILS

DETAIL SHEET NOTE:

1. ALL DETAILS ARE SUBJECT TO CHANGE WITHOUT NOTICE.


CHECK WITH THE TOWN OF WALPOLE PRIOR TO USING THESE
DETAILS FOR THE MOST UP TO DATE REVISIONS.

2. IT IS THE DESIGNERS SOLE RESPONSIBILITY TO DETERMINE THE SUITABILITY OF A PARTICULAR DETAIL.

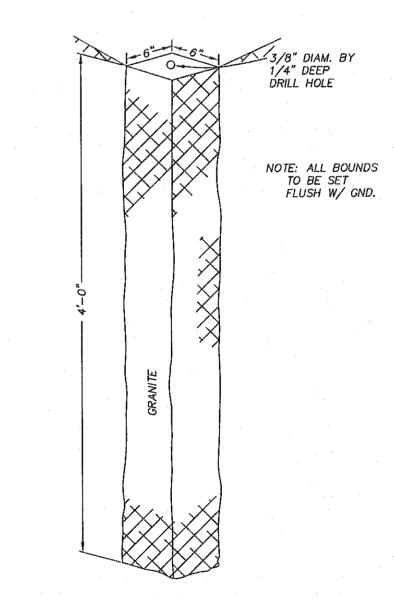

GRANITE MONUMENT DETAIL

(NO SCALE)

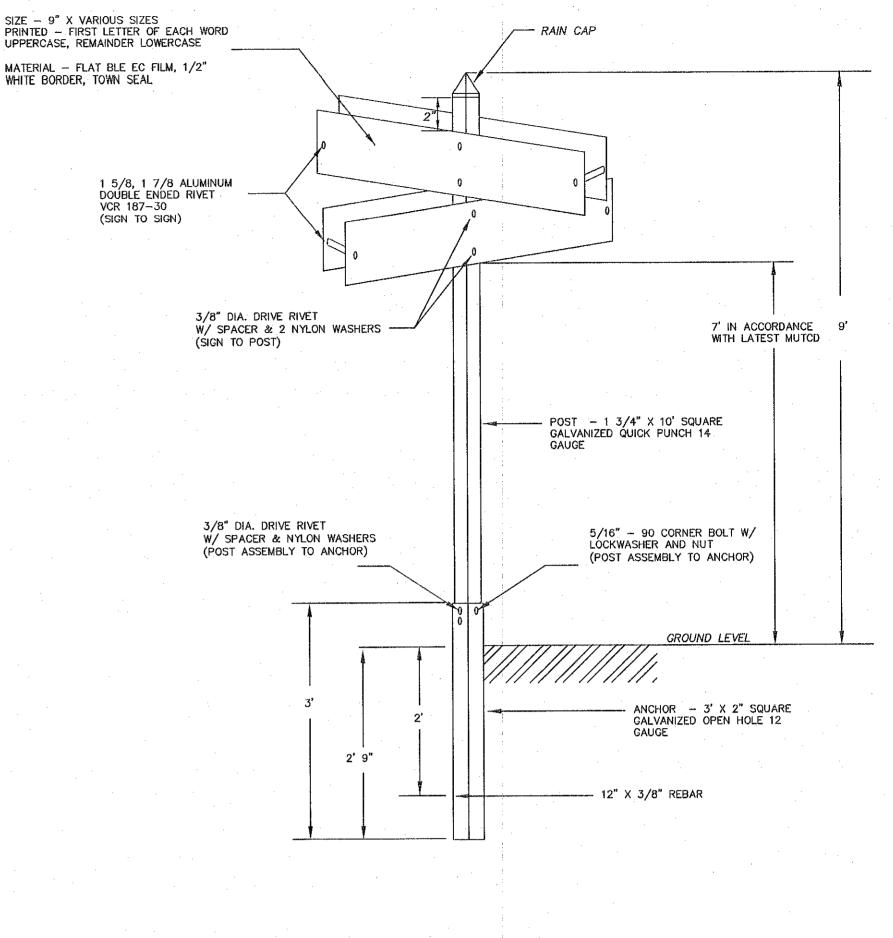

TYPICAL STREET SIGN DETAIL

(NO SCALE)

RECEIVED & RECORDED FROM THE ZONING
BOARD OF APPEALS, APPROVAL OF THIS PLAN
AND NO APPEAL HAS BEEN TAKEN FOR TWENTY
DAYS NEXT AFTER RECEIPT AND RECORDING OF
SAME.

TOWN CLERK

DATE

APPROVED BY
ZONING BOARD OF APPEALS

DATE ENDORSED:

SPECIAL PERMIT & SITE DEVELOPMENT PLAN "UNION SQUARE VILLAGE" WALPOLE, MASSACHUSETTS


APPLICANT:
WALL STREET DEVELOPMENT CORP.
P.O. BOX 272
WESTWOOD, MA 02090

SHEET: 9 of 12



Town of Walpole

Date:	3-28-19
Scale:	AS SHOWN
Drawn By:	R. ROSA
Checked By:	C. JOHNSON
Appr. By:	M. WALKER

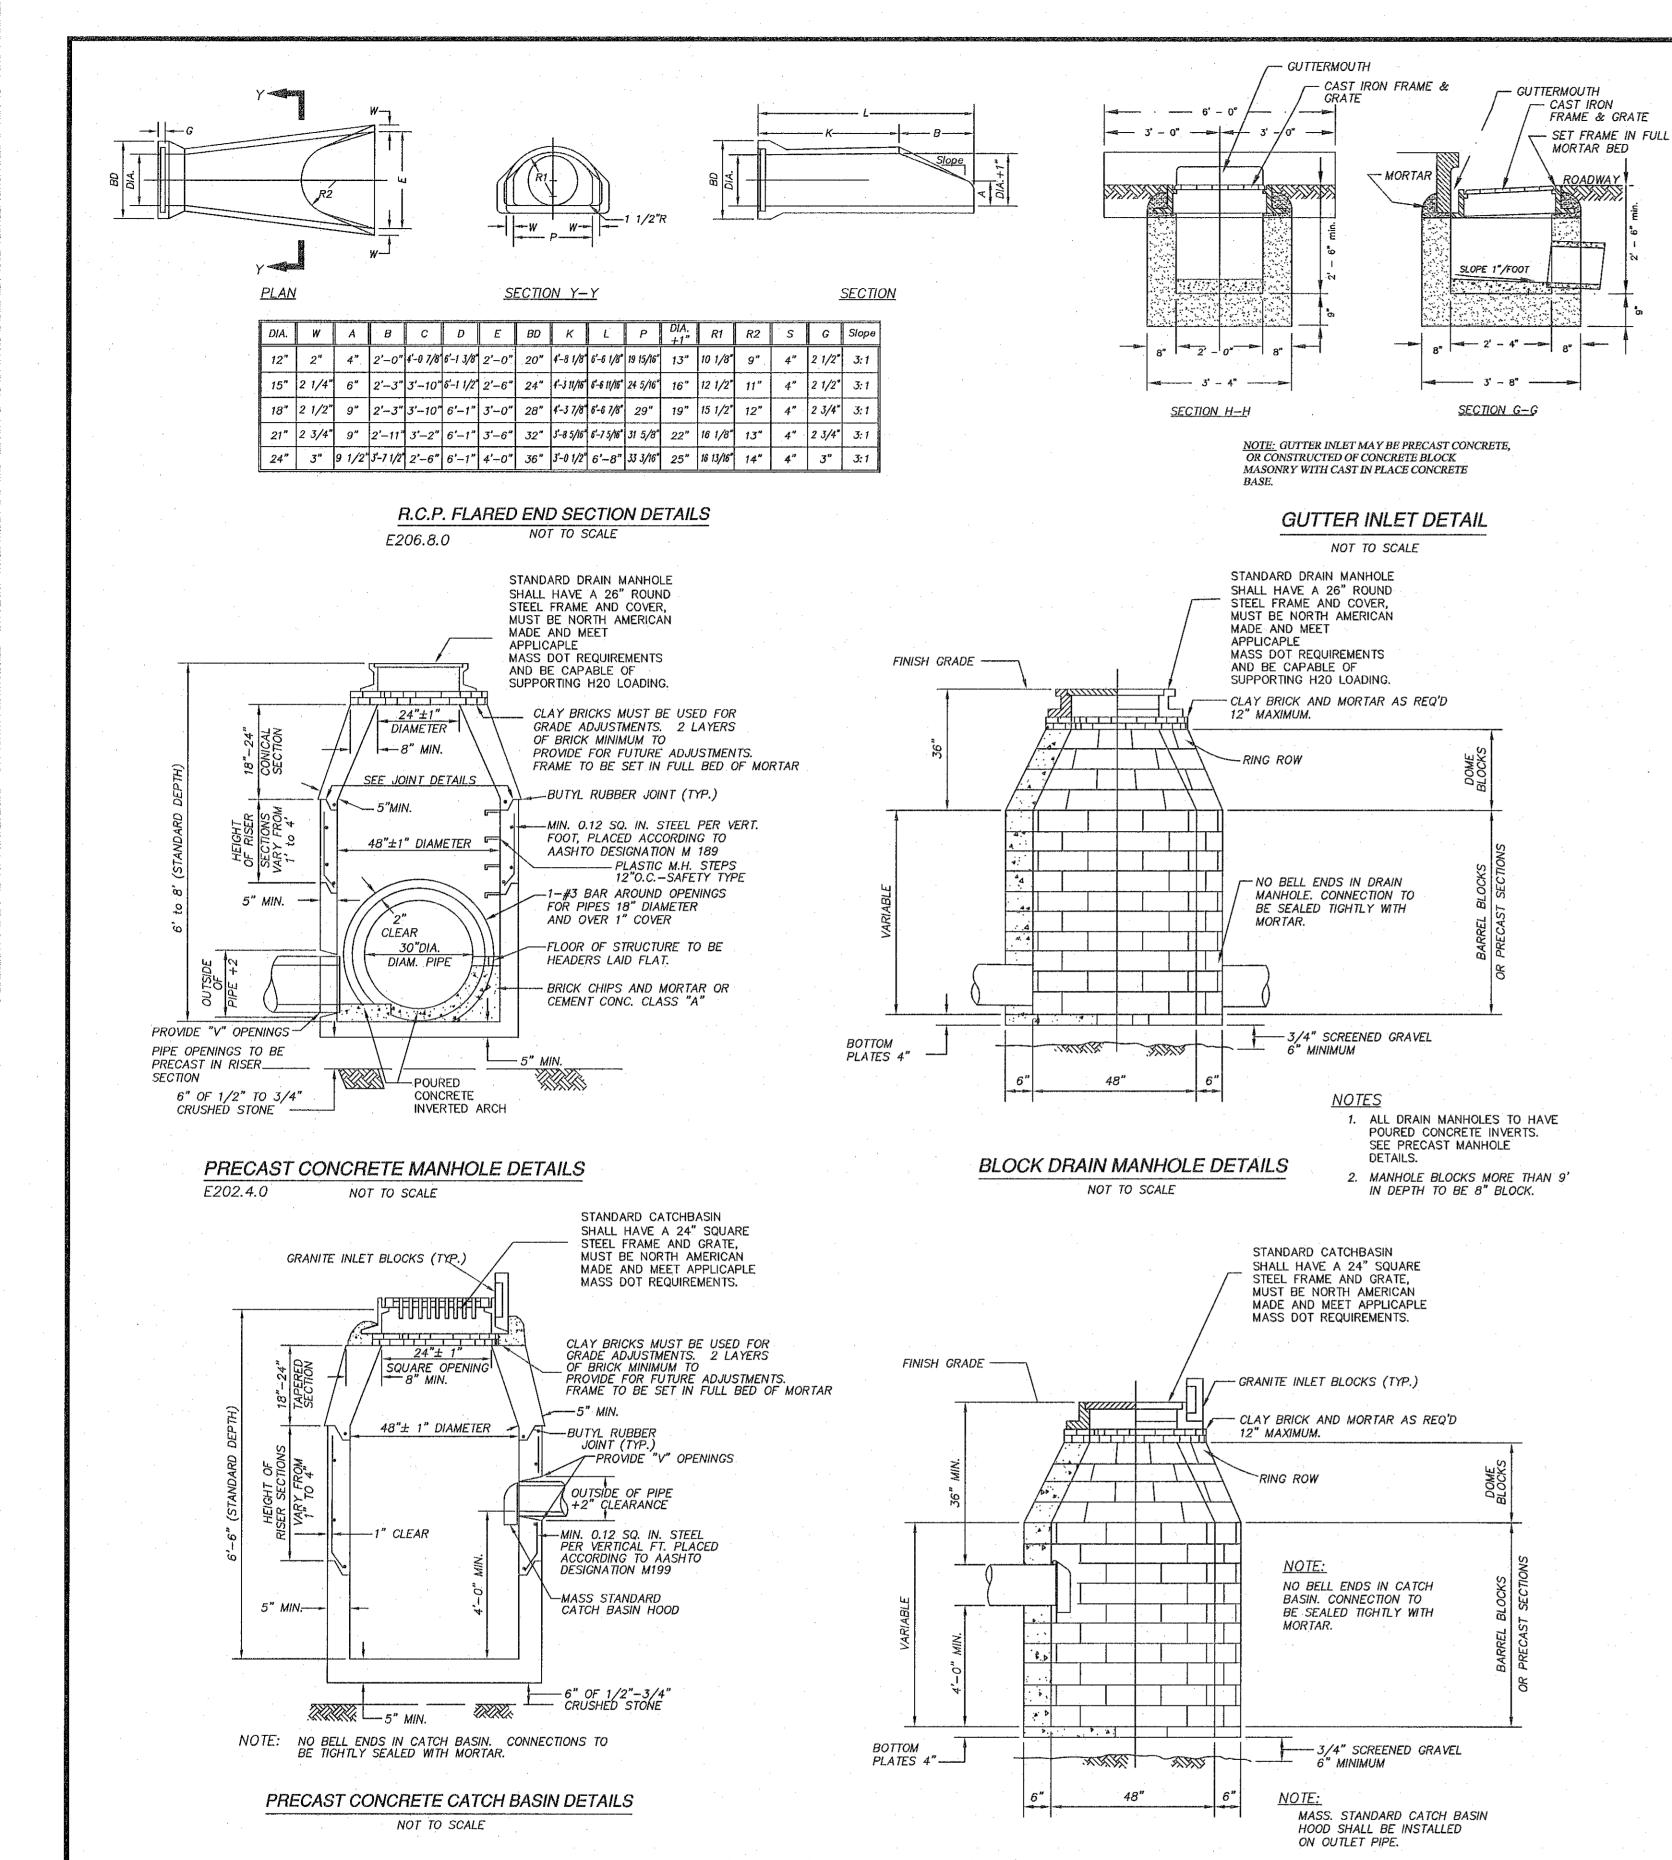


BLOCK CATCH BASIN DETAILS


NOT TO SCALE

	PROJECT P.	ATH		
Carlo Carlo	REV. #	DESCRIPTION	DATE	BY
No.				
. Michigan				
0.550				
	<u> </u>			
9.840	•			
				*

TOWN OF WALPOLE, MASSACHUSETTS
DEPARTMENT OF PUBLIC WORKS
PLAN SHOWING TYPICAL
DRAINAGE CONSTRUCTION DETAILS

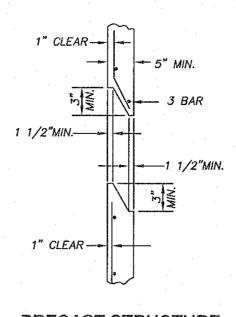

PRECAST STRUCTURE
JOINT DETAILS
NOT TO SCALE

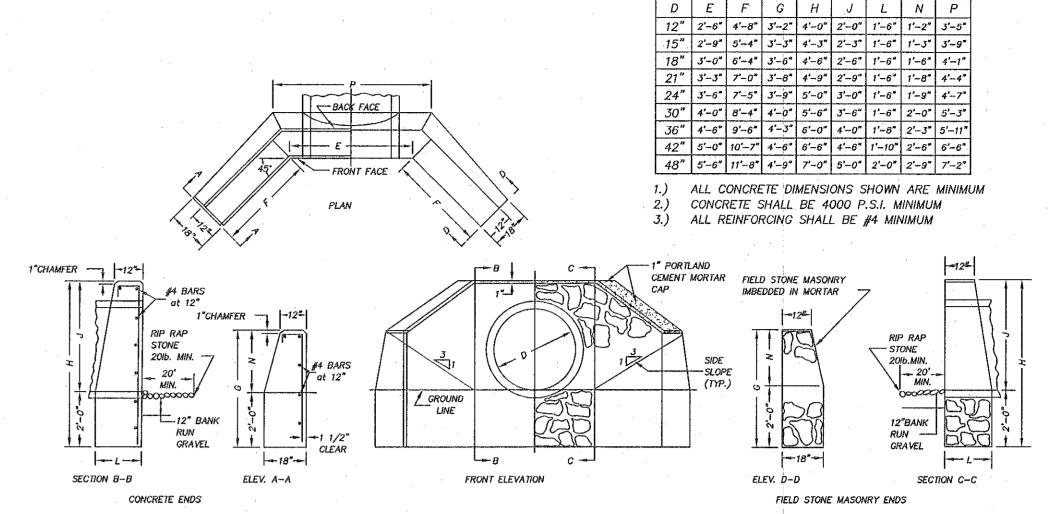


CONCRETE AND FIELD STONE MASONARY HEADWALL \ WINGWALL DETAILS

E206.5.0


NOT TO SCALE

E206.6.0

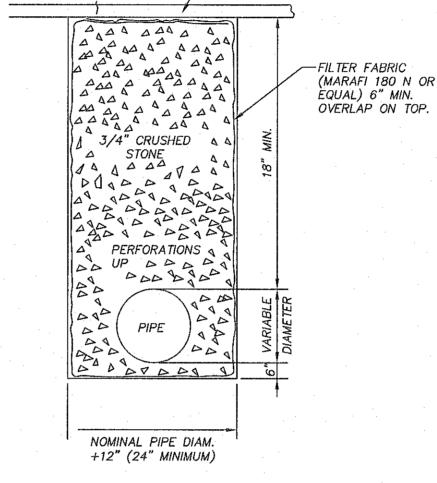

-- NORMAL TREATMENT

SUBDRAIN DETAL

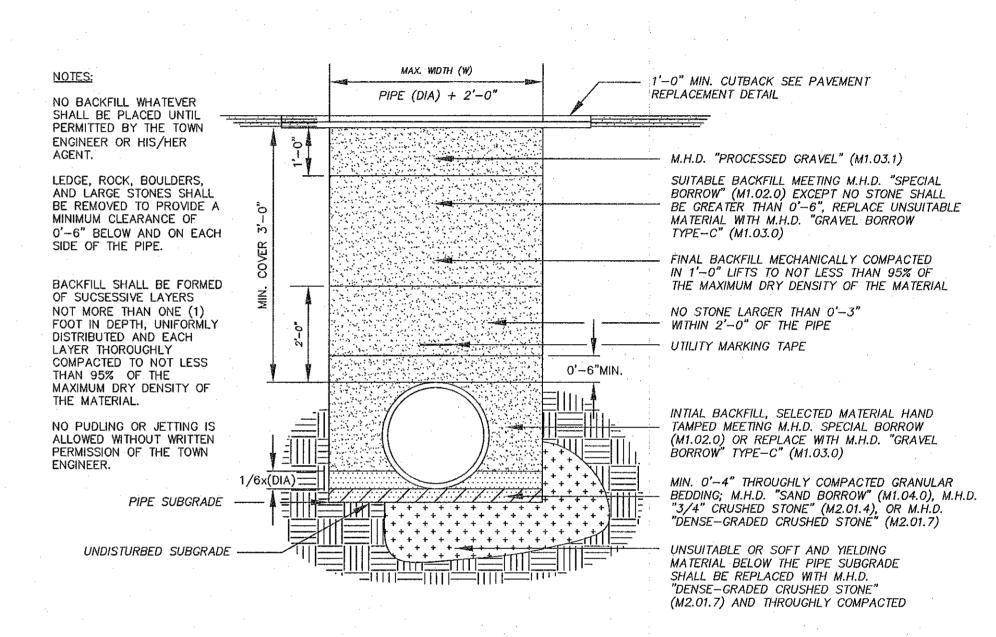

TO BE FILLED WITH
3/4" SCREENED
GRAVEL.

BOTTOM PLATES

BLOCK CATCH BASIN & MANHOLE BOTTOM DETAILS

NOT TO SCALE

I TOWN CLERK OF THE TOWN OF WALPOLE
RECEIVED & RECORDED FROM THE ZONING
BOARD OF APPEALS, APPROVAL OF THIS PLAN
AND NO APPEAL HAS BEEN TAKEN FOR TWENTY
DAYS NEXT AFTER RECEIPT AND RECORDING OF
SAME.

TOWN CLERK

DATE

TYPICAL DRAIN TRENCH DETAIL

NOT TO SCALE

DATE APPROVED:

DATE ENDORSED:

SPECIAL PERMIT & SITE DEVELOPMENT PLAN "UNION SQUARE VILLAGE"

WALPOLE, MASSACHUSETTS

APPLICANT:

WALL STREET DEVELOPMENT CORP.
P.O. BOX 272
WESTWOOD, MA 02090

SHEET: 10 of 12



Town	of	Walpole
Date:		3-28-19


Date:	3-28-19
Scale:	AS SHOWN
Drawn By:	R. ROSA
Checked By:	C. JOHNSON
Appr. By:	M. WALKER


DETAIL SHEET NOTE:

1. ALL DETAILS ARE SUBJECT TO CHANGE WITHOUT NOTICE.

CHECK WITH THE TOWN OF WALPOLE PRIOR TO USING THESE
DETAILS FOR THE MOST UP TO DATE REVISIONS.

2. IT IS THE DESIGNERS SOLE RESPONSIBILITY TO DETERMINE THE SUITABILITY OF A PARTICULAR DETAIL.

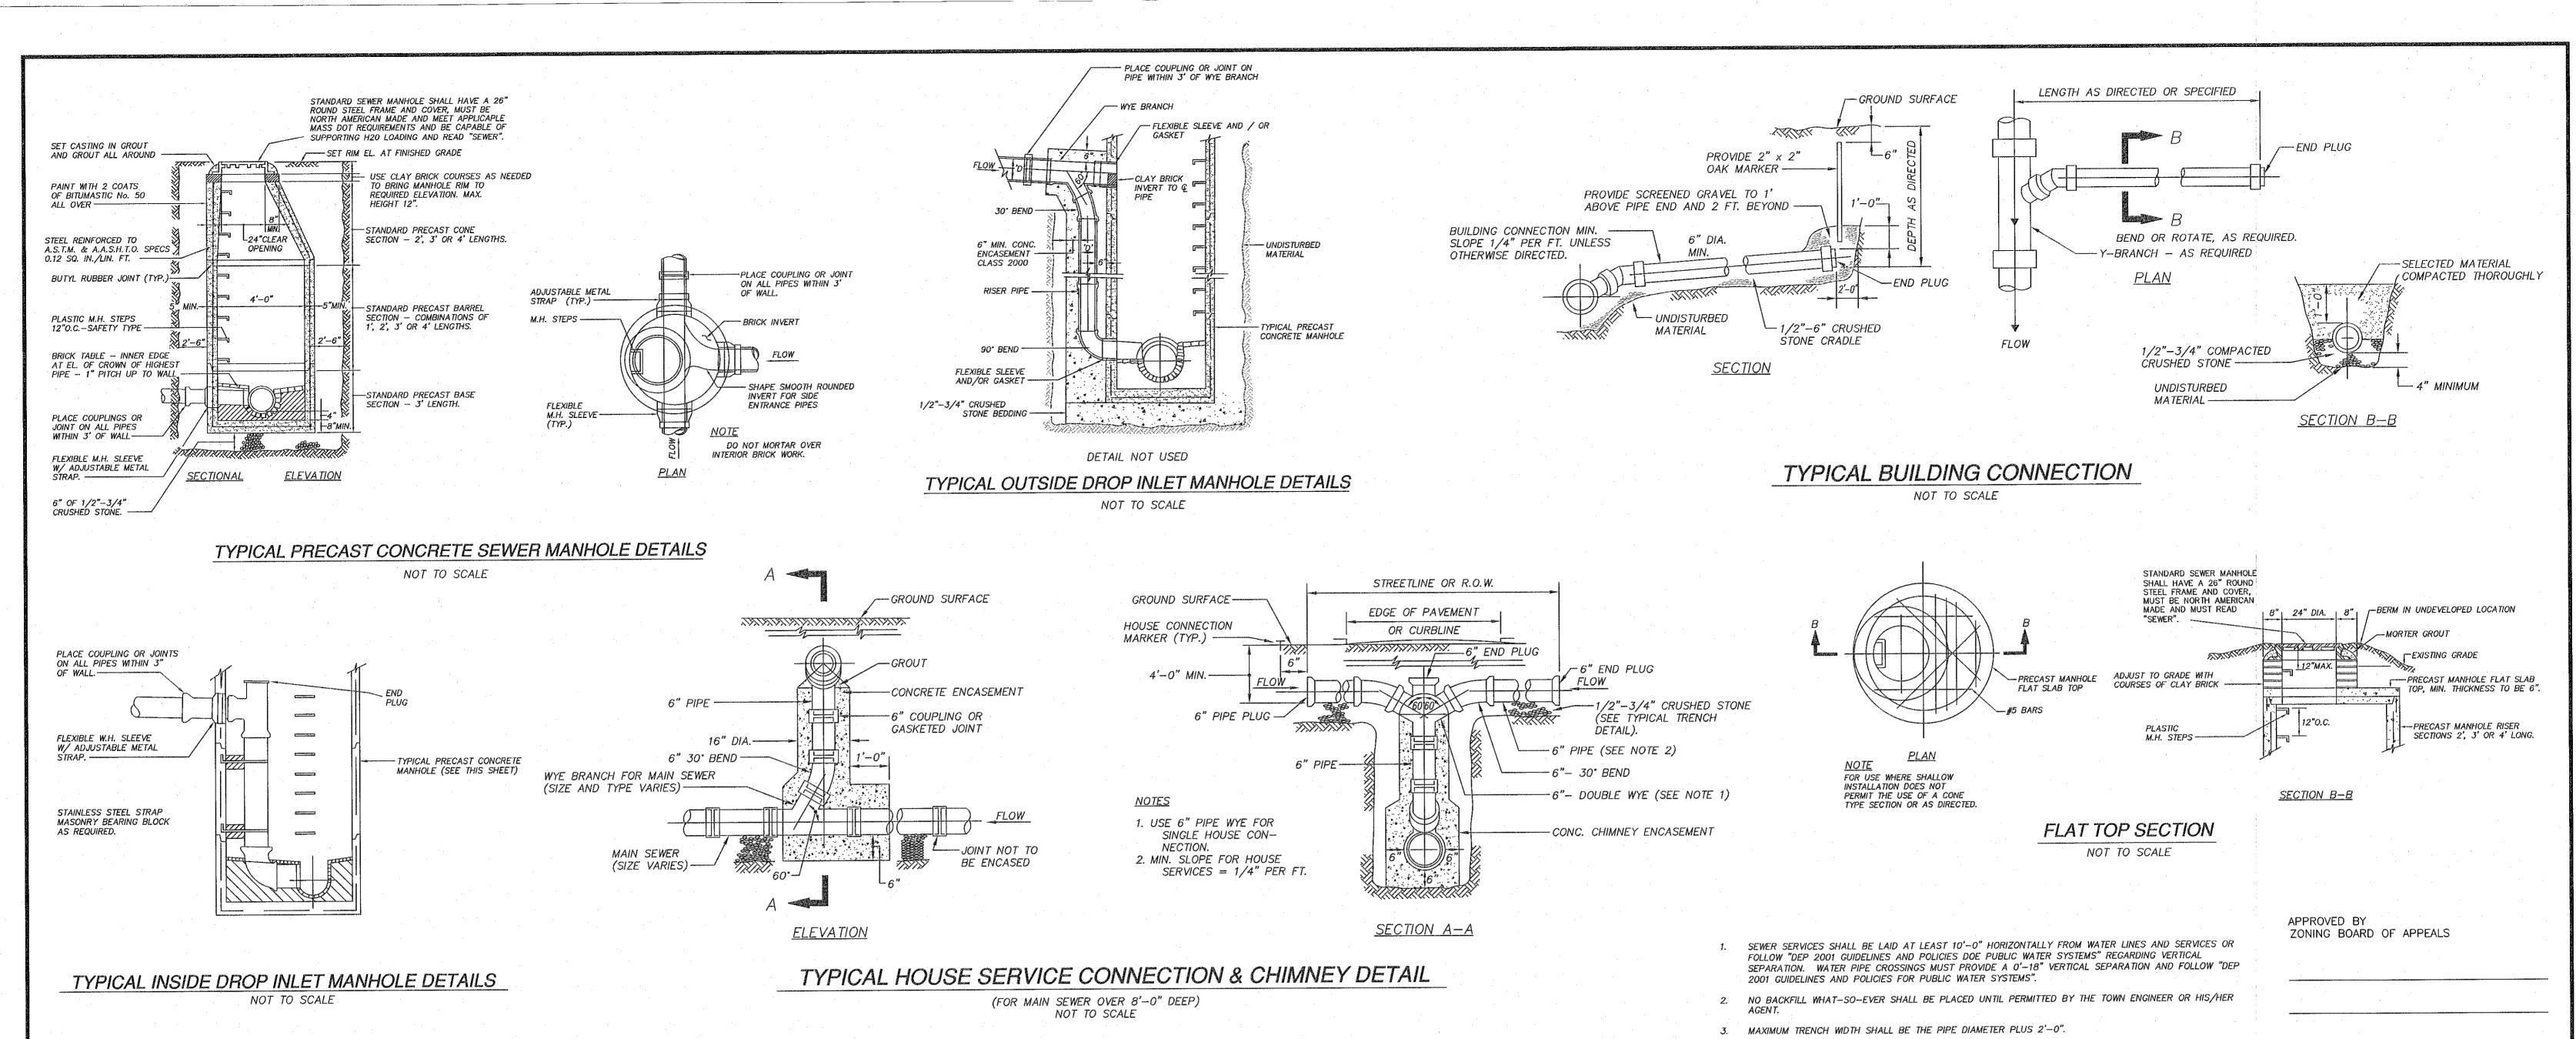

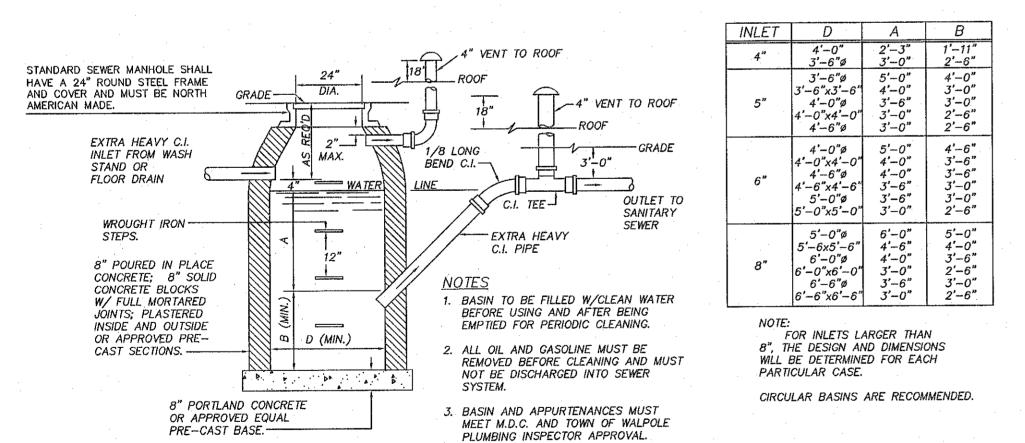


STANDARD M.D.C. CATCH BASIN & GASOLINE TRAP DETAILS

NOT TO SCALE

REV. #		DESCRIPTION	.	DATÉ	BY
					·
	4				

TOWN OF WALPOLE, MASSACHUSETTS
DEPARTMENT OF PUBLIC WORKS
PLAN SHOWING TYPICAL
SEWERAGE CONSTRUCTION DETAILS

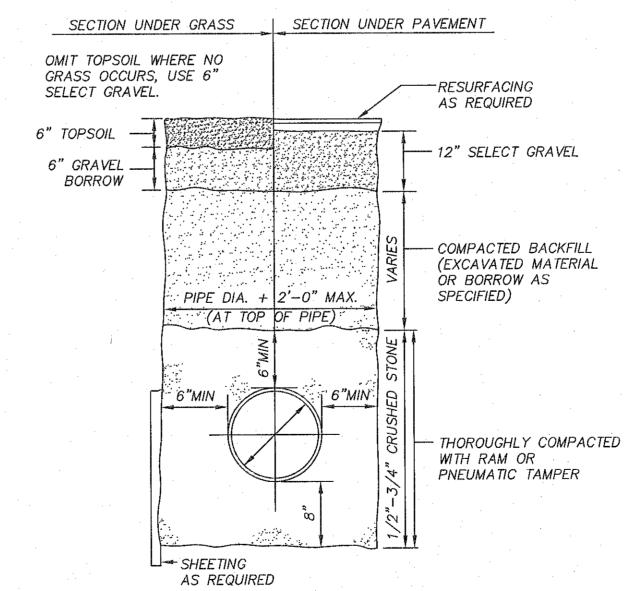

TYPICAL SEWER TRENCH DETAIL NOT TO SCALE

DETAIL SHEET NOTE:

1. ALL DETAILS ARE SUBJECT TO CHANGE WITHOUT NOTICE.

CHECK WITH THE TOWN OF WALPOLE PRIOR TO USING THESE

DETAILS FOR THE MOST UP TO DATE REVISIONS.

2. IT IS THE DESIGNERS SOLE RESPONSIBILITY TO DETERMINE THE SUITABILITY OF A PARTICULAR DETAIL.

- 4. LEDGE, ROCK, BOULDERS AND LARGE STONES SHALL BE REMOVED TO PROVIDE A MINIMUM CLEARANCE OF 0'-6" BELOW AND ON EACH SIDE OF THE PIPE.
- 5. SEWER SERVICES SHALL BE BEDDED ON A MINIMUM OF 0'-4" THOROUGHLY COMPACTED GRANULAR BEDDING CONSISTING OF 3/4" CRUSHED STONE M.H.D. (M2.01.4).
- 6. SEWER SERVICES SHALL HAVE A MINIMUM DIAMETER OF 0'-6" AND A MINIMUM SLOPE OF 2.0% (FT/FT)
- THE SIDES OF THE SERVICES SHALL BE BACKFILLED AND HAND TAMPED. INITIAL BACKFILL MATERIAL SHALL CONTAIN NO STONES LARGER THAN 0'-3".
 DEBRIS, FROZEN MATERIAL, LARGE CLODS OR STONES, ORGANIC MATTER, OR OTHER MATERIAL DEEMED
- UNSUITABLE BY THE ENGINEER SHALL NOT BE USED AS BACKFILL WITHIN TWO (2) FEET OF THE TOP OF THE PIPE.
- 9. SEWER SERVICES SHALL HAVE A MINIMUM COVER OF 4'-0" FROM THE TOP OF THE PIPE. SERVICES UNDER PAVED SURFACES OR SIDEWALKS SHALL BE FORMED OF SUCCESSIVE LAYERS NOT MORE THAN ONE (1) FOOT IN DEPTH, UNIFORMLY DISTRIBUTED AND EACH LAYER THOROUGHLY COMPACTED TO NOT LESS THAN 95% OF THE MAXIMUM DRY DENSITY OF THE MATERIAL. JACKING IS NOT ALLOWED.
- 10. NO PUDDLING OR JETTING IS ALLOWED WITHIN THE PUBLIC LAYOUT WITHOUT WRITTEN PERMISSION OF THE TOWN ENGINEER.

FORCE MAIN SPECIFICATIONS

FORCE MAIN SPECIFICATIONS FOR \leq 2" COMMON FORCE MAIN C.O. @ 200' FORCE MAIN SHALL BE MADE OF BLACK OR BLUES HDPE SDR 11 FOR LINES \leq 2". SINGLE SERVICE LINES SHALL BE 1.5" C.T.S. (COPPER

TRACKER WIRE SHALL BE 10GA SOLID COPPER.

USE OF REDUNDANT SWING CHECK VALVES REQUIRED. BALL CHECK VALVES SHALL BE PROHIBITED.

ALL FITTINGS SHALL BE MADE OF STAINLESS STEEL.

CORPORATION ON COMMON USE MAINS SHALL BE REQUIRED

MASSACE SETTING SETTIN

DATE

I TOWN CLERK OF THE TOWN OF WALPOLE

TOWN CLERK

RECEIVED & RECORDED FROM THE ZONING

BOARD OF APPEALS, APPROVAL OF THIS PLAN

AND NO APPEAL HAS BEEN TAKEN FOR TWENT


DAYS NEXT AFTER RECEIPT AND RECORDING OF

SPECIAL PERMIT & SITE DEVELOPMENT PLAN "UNION SQUARE VILLAGE" WALPOLE, MASSACHUSETTS

WALL STREET DEVELOPMENT CORP.
P.O. BOX 272
WESTWOOD, MA 02090


SHEET: 11 of 12

JownofWalpoleDate:3-28-19Scale:AS SHOWNDrawn By:R. ROSAChecked By:C. JOHNSONAppr. By:M. WALKER

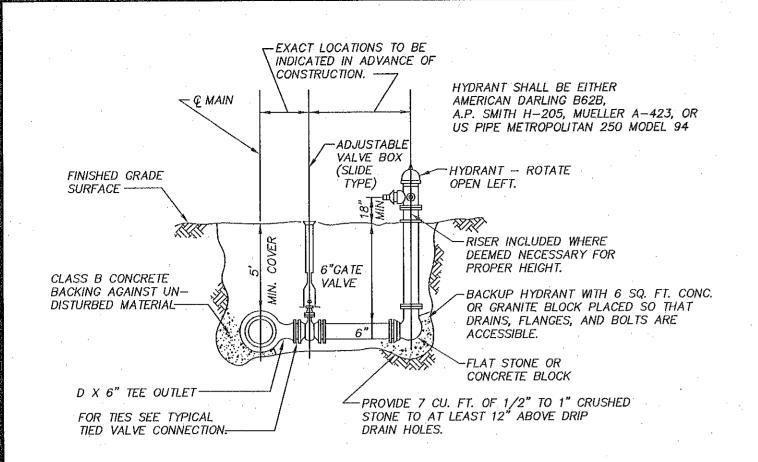

TYPICAL HYDRANT ASSEMBLY DETAIL

NOT TO SCALE

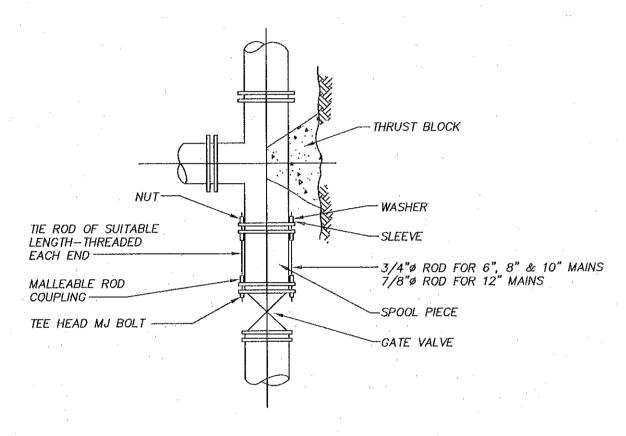


TYPICAL TIED MECHANICAL JOINT VALVE CONNECTION DETAILS

NOT TO SCALE


NOTES

- 1. WATER SERVICES SHALL BE LAID AT LEAST 10'-0" HORIZONTALLY FROM SEWER LINES AND SERVICES OR FOLLOW "DEP 2001 GUIDELINES AND POLICIES DOE PUBLIC WATER SYSTEMS" REGARDING VERTICAL SEPARATION. SEWER CROSSINGS MUST PROVIDE A 0'-18" VERTICAL SEPARATION AND FOLLOW "DEP 2001 GUIDELINES AND POLICIES FOR PUBLIC WATER SYSTEMS".
- 2. WATER SERVICES GREATER THAN ONE HUNDRED (100) FEET IN LENGTH SHALL BE FIRST CONNECTED TO A WATER METER PIT LOCATED AT THE PROPERTY LINE.
- 3. NO BACKFILL WHAT-SO-EVER SHALL BE PLACED UNTIL PERMITTED BY THE TOWN ENGINEER OR HIS/HER
- 4. LEDGE, ROCK, BOULDERS AND LARGE STONES SHALL BE REMOVED TO PROVIDE A MINIMUM CLEARANCE OF 0'-6" BELOW AND ON EACH SIDE OF THE PIPE.
- 5. WATER SERVICES SHALL BE BEDDED ON A MINIMUM OF 0'-4" THOROUGHLY COMPACTED GRANULAR BEDDING CONSISTING OF COURSE SAND M.H.D. (M2.01.4). STONE DUST SHALL NOT BE USED AS BEDDING OR BACKFILL.
- 6. THE INITIAL BACKFILL MATERIAL WITHIN 0'-6" OF THE PIPE SHALL CONSIST OF COURSE SAND M.H.D. (M2.01.4).
- 7. DEBRIS, FROZEN MATERIAL, LARGE CLODS OR STONES, ORGANIC MATTER, OR OTHER MATERIAL DEEMED UNSUITABLE BY THE ENGINEER SHALL NOT BE USED AS BACKFILL WITHIN TWO (2) FEET OF THE TOP OF THE DIPE
- 8. WATER SERVICES SHALL HAVE A MINIMUM COVER OF 5'-0" FROM THE TOP OF THE PIPE. SERVICES UNDER PAVED SURFACES OR SIDEWALKS SHALL BE FORMED OF SUCCESSIVE LAYERS NOT MORE THAN ONE (1) FOOT IN DEPTH, UNIFORMLY DISTRIBUTED AND EACH LAYER THOROUGHLY COMPACTED TO NOT LESS THAN 95% OF THE MAXIMUM DRY DENSITY OF THE MATERIAL. JACKING IS NOT ALLOWED.
- 9. NO PUDDLING OR JETTING IS ALLOWED WITHIN THE PUBLIC LAYOUT WITHOUT WRITTEN PERMISSION OF THE TOWN ENGINEER.

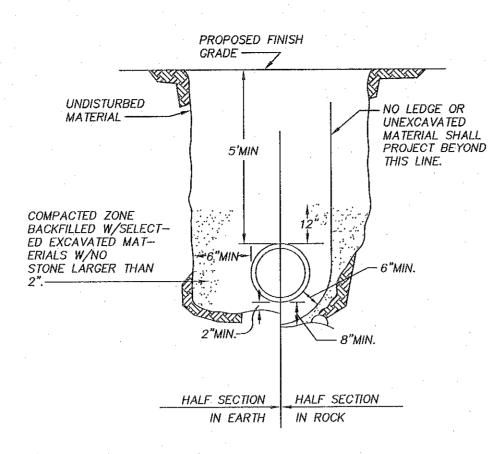

WATER MAIN TRENCH DETAIL


NOT TO SCALE

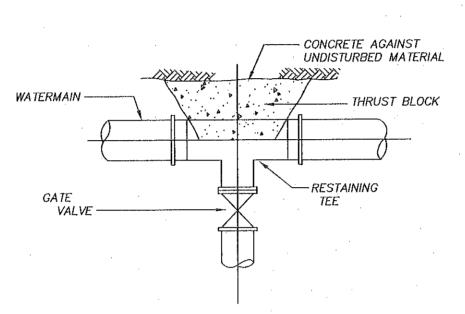

TYPICAL LATERAL GATE VALVE CONNECTION DETAILS

NOT TO SCALE

NOTE: WRAP BOLTS/FITTINGS IN PLASTIC WHERE MIXED CONCRETE IS USED.

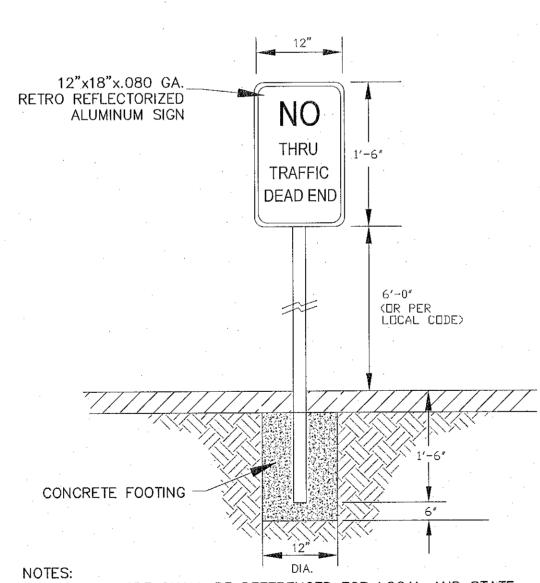



1. SPECIFIC CODE SHALL BE REFERENCED FOR LOCAL AND STATE REQUIREMENTS.
2. PROVIDED (1) SIGN PER HANDICAP SPACE. SEE SITE PLAN FOR EXACT LOCATION

NO THRU TRAFFIC SIGN

Annual Control of the	Agriculture of the Control of September 1 (1997) and the control of the control o	the state of the process of the state of the	The state of the s	and the second s	
PROJECT F	PATH				
REV. #		DESCRIPTION		DATE	BY
1					
					·

TOWN OF WALPOLE, MASSACHUSETTS
DEPARTMENT OF PUBLIC WORKS
PLAN SHOWING TYPICAL
WATER MAIN CONSTRUCTION DETAILS

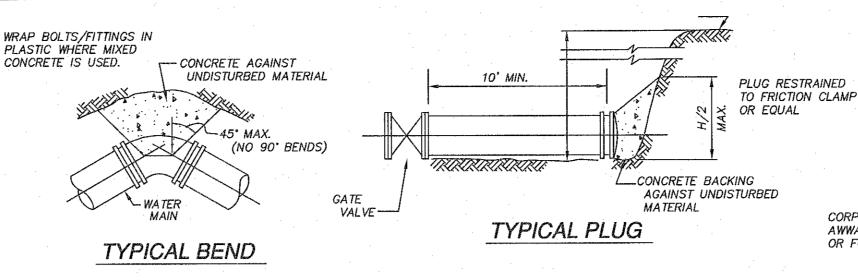

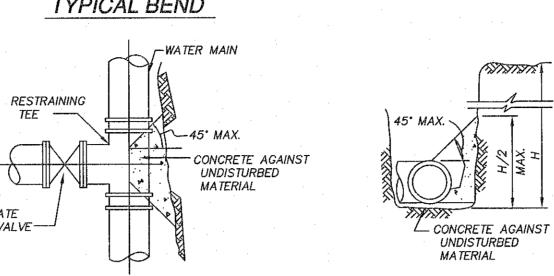

TYPICAL TEE


TYPICAL SECTION

NOTE: CONCRETE FOR THRUST BLOCKS SHALL BE
NO LONGER THAN THE RATIO OF 2 1/2: 5 1/2
AND SHALL HAVE A MINIMUM COMPRESSION
STRENGTH OF 2000 PSI (SO THAT FLANGES
AND BOLTS ARE ACCESSIBLE.)

BEARING AREAS OF THRUST BLOCKS (BEARING AREA IN SQUARE FT.)						
PIPE SIZE 1/4 BEND 1/8 BEND 1/16 BEND PLUG TEES						
6 AND 8 8 8				8		
10 AND 12 22 13 8 16						

TYPICAL THRUST BLOCK DETAIL

NOT TO SCALE

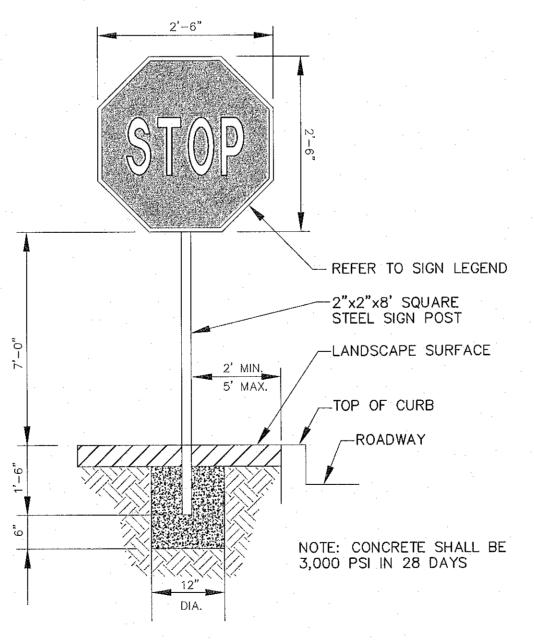

STOP SIGNS SHALL BE CONSISTENT W/CURRENT MANUAL ON UNIFORM TRAFFIC CONTROL DEVICES STANDARDS AND GUIDELINES.

STOP SIGN DETAIL

(1101 10 30/122)


DETAIL SHEET NOTE:

1. ALL DETAILS ARE SUBJECT TO CHANGE WITHOUT NOTICE.

CHECK WITH THE TOWN OF WALPOLE PRIOR TO USING THESE

DETAILS FOR THE MOST UP TO DATE REVISIONS.


2. IT IS THE DESIGNERS SOLE RESPONSIBILITY TO DETERMINE THE SUITABILITY OF A PARTICULAR DETAIL.

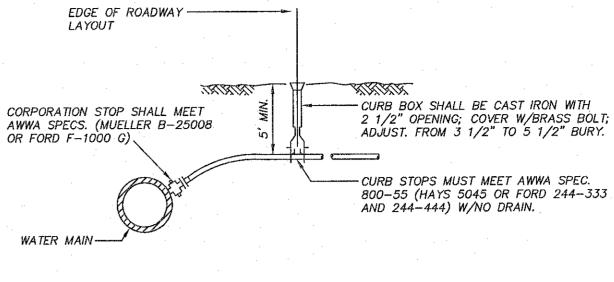

NOTE

COPPER TUBING SHALL MEET AWWA SPEC.
76-CR TYPE K OR FEDERAL SPEC. WWT-799

1 1/2" AND LARGER SERVICES ARE REQUIRED TO HAVE A SADDLE.

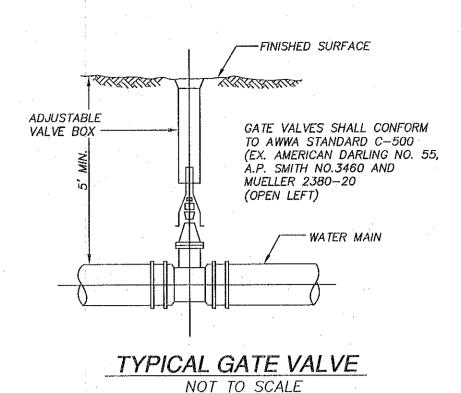

- C.I. OR D.I. FULL BODIED

-FLANGED TAPPING GATE VALVE

TAPPING SLEEVE


TAPPING SLEEVE AND VALVE DETAILS

NOT TO SCALE

BLOCK

TYPICAL SERVICE CONNECTION

NOT TO SCALE

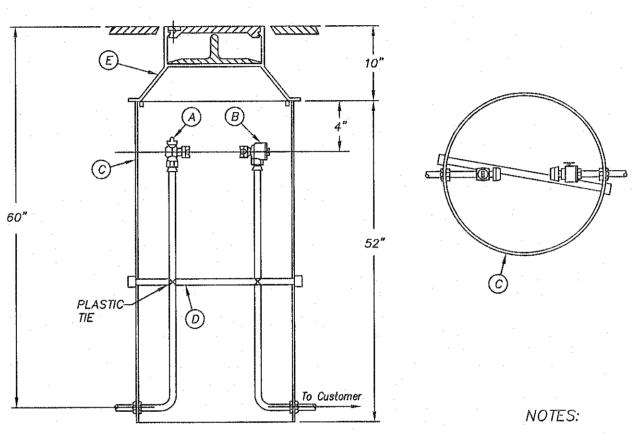

ITEM DESCRIPTION CAT No.

A ANGLE BALL VALVE BA13-232W

B DUAL ANGLE CHECK VALVE HHA31-3230

C 20" I.D. PVC PIPE

D 1/2" PVC SUPPORT & CAPS

E METER BOX COVER & LID W-3

* ORDERED SEPARATELY

1. ALL SERVICE SHALL ENTER THE PIT AT A 90° ANGLE TO THE STREET.

2. TO BE USED FOR DWELLINGS WHICH EXCEED A DISTANCE OF 100' FROM FRONT PROPERTY LINES.

3. PLASTIC SERVICE PIPE MAY ONLY BE USED ON PRIVATE SIDE OF METER PIT.

METER PIT SPECIFICATIONS

NOT TO SCALE

I TOWN CLERK OF THE TOWN OF WALPOLE RECEIVED & RECORDED FROM THE ZONING BOARD OF APPEALS, APPROVAL OF THIS PLAN AND NO APPEAL HAS BEEN TAKEN FOR TWENTY DAYS NEXT AFTER RECEIPT AND RECORDING OF SAME.

TOWN CLERK

DATE

APPROVED BY ZONING BOARD OF APPEALS

DATE APPROVED

SPECIAL PERMIT & SITE DEVELOPMENT PLAN "UNION SQUARE VILLAGE" WALPOLE, MASSACHUSETTS


APPLICANT:
WALL STREET DEVELOPMENT CORP.
P.O. BOX 272
WESTWOOD, MA 02090


SHEET: 12 of 12



Town of Walpole

Date:3-28-19Scale:AS SHOWNDrawn By:R. ROSAChecked By:C. JOHNSONAppr. By:M. WALKER

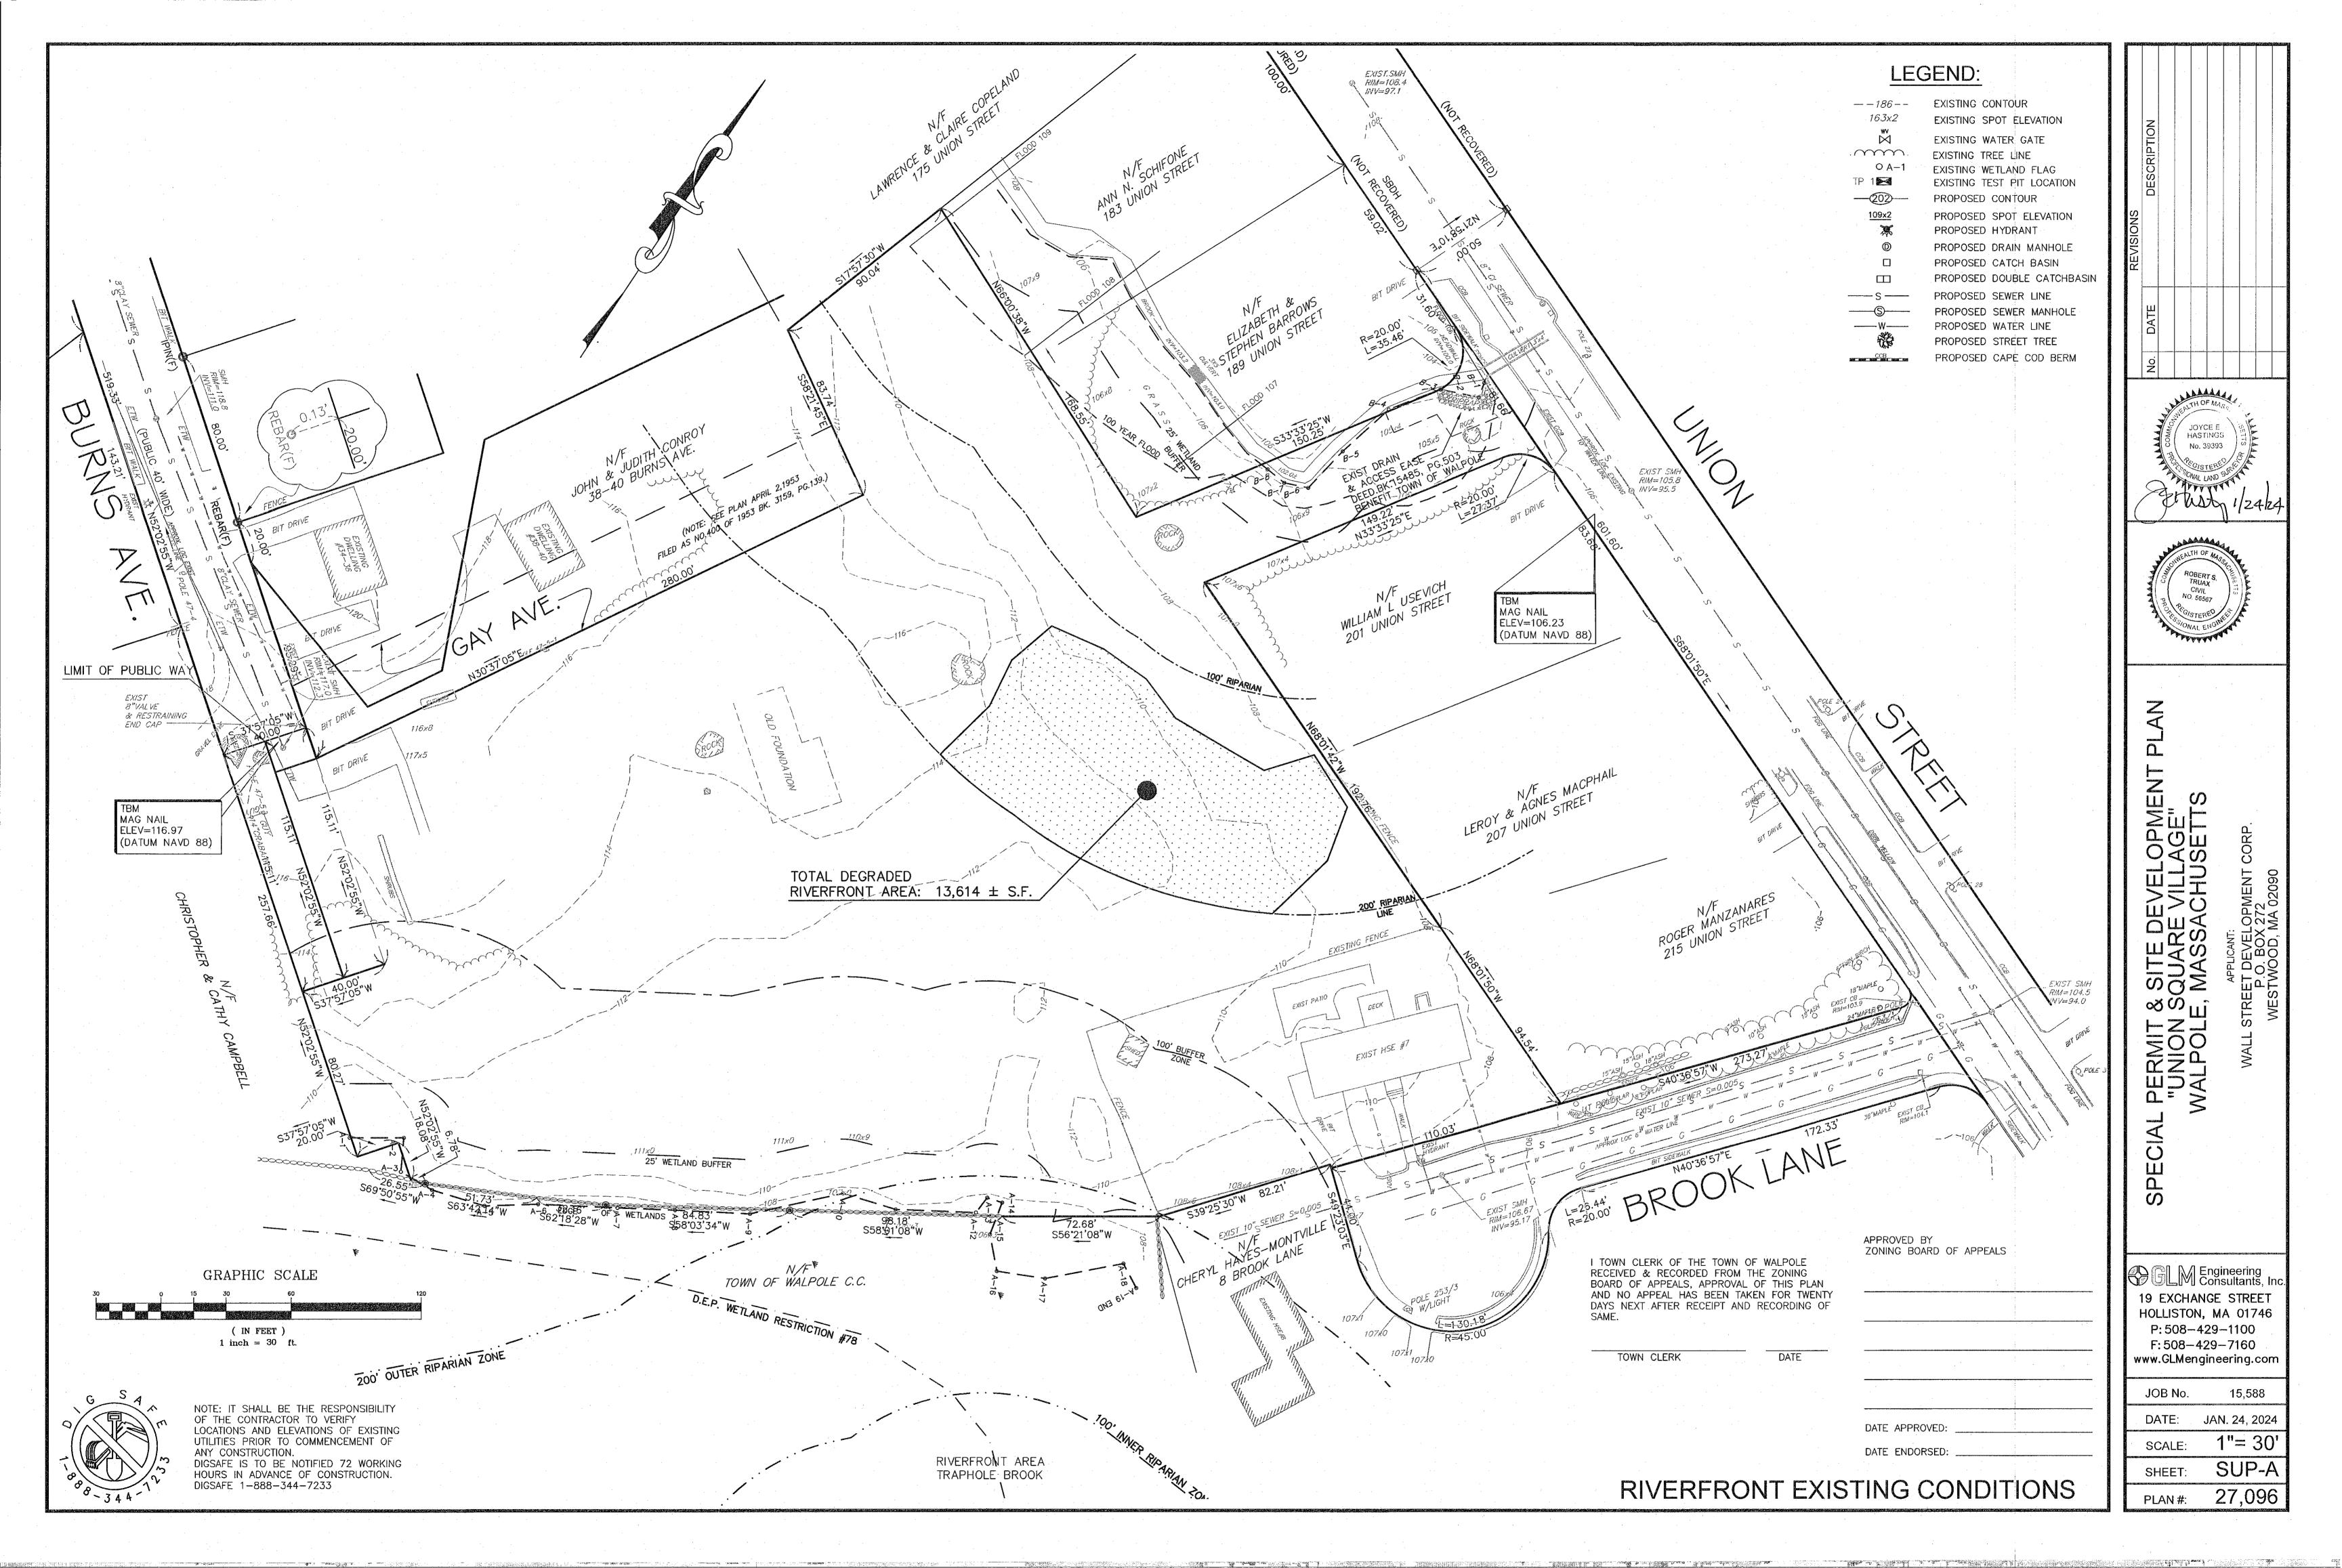

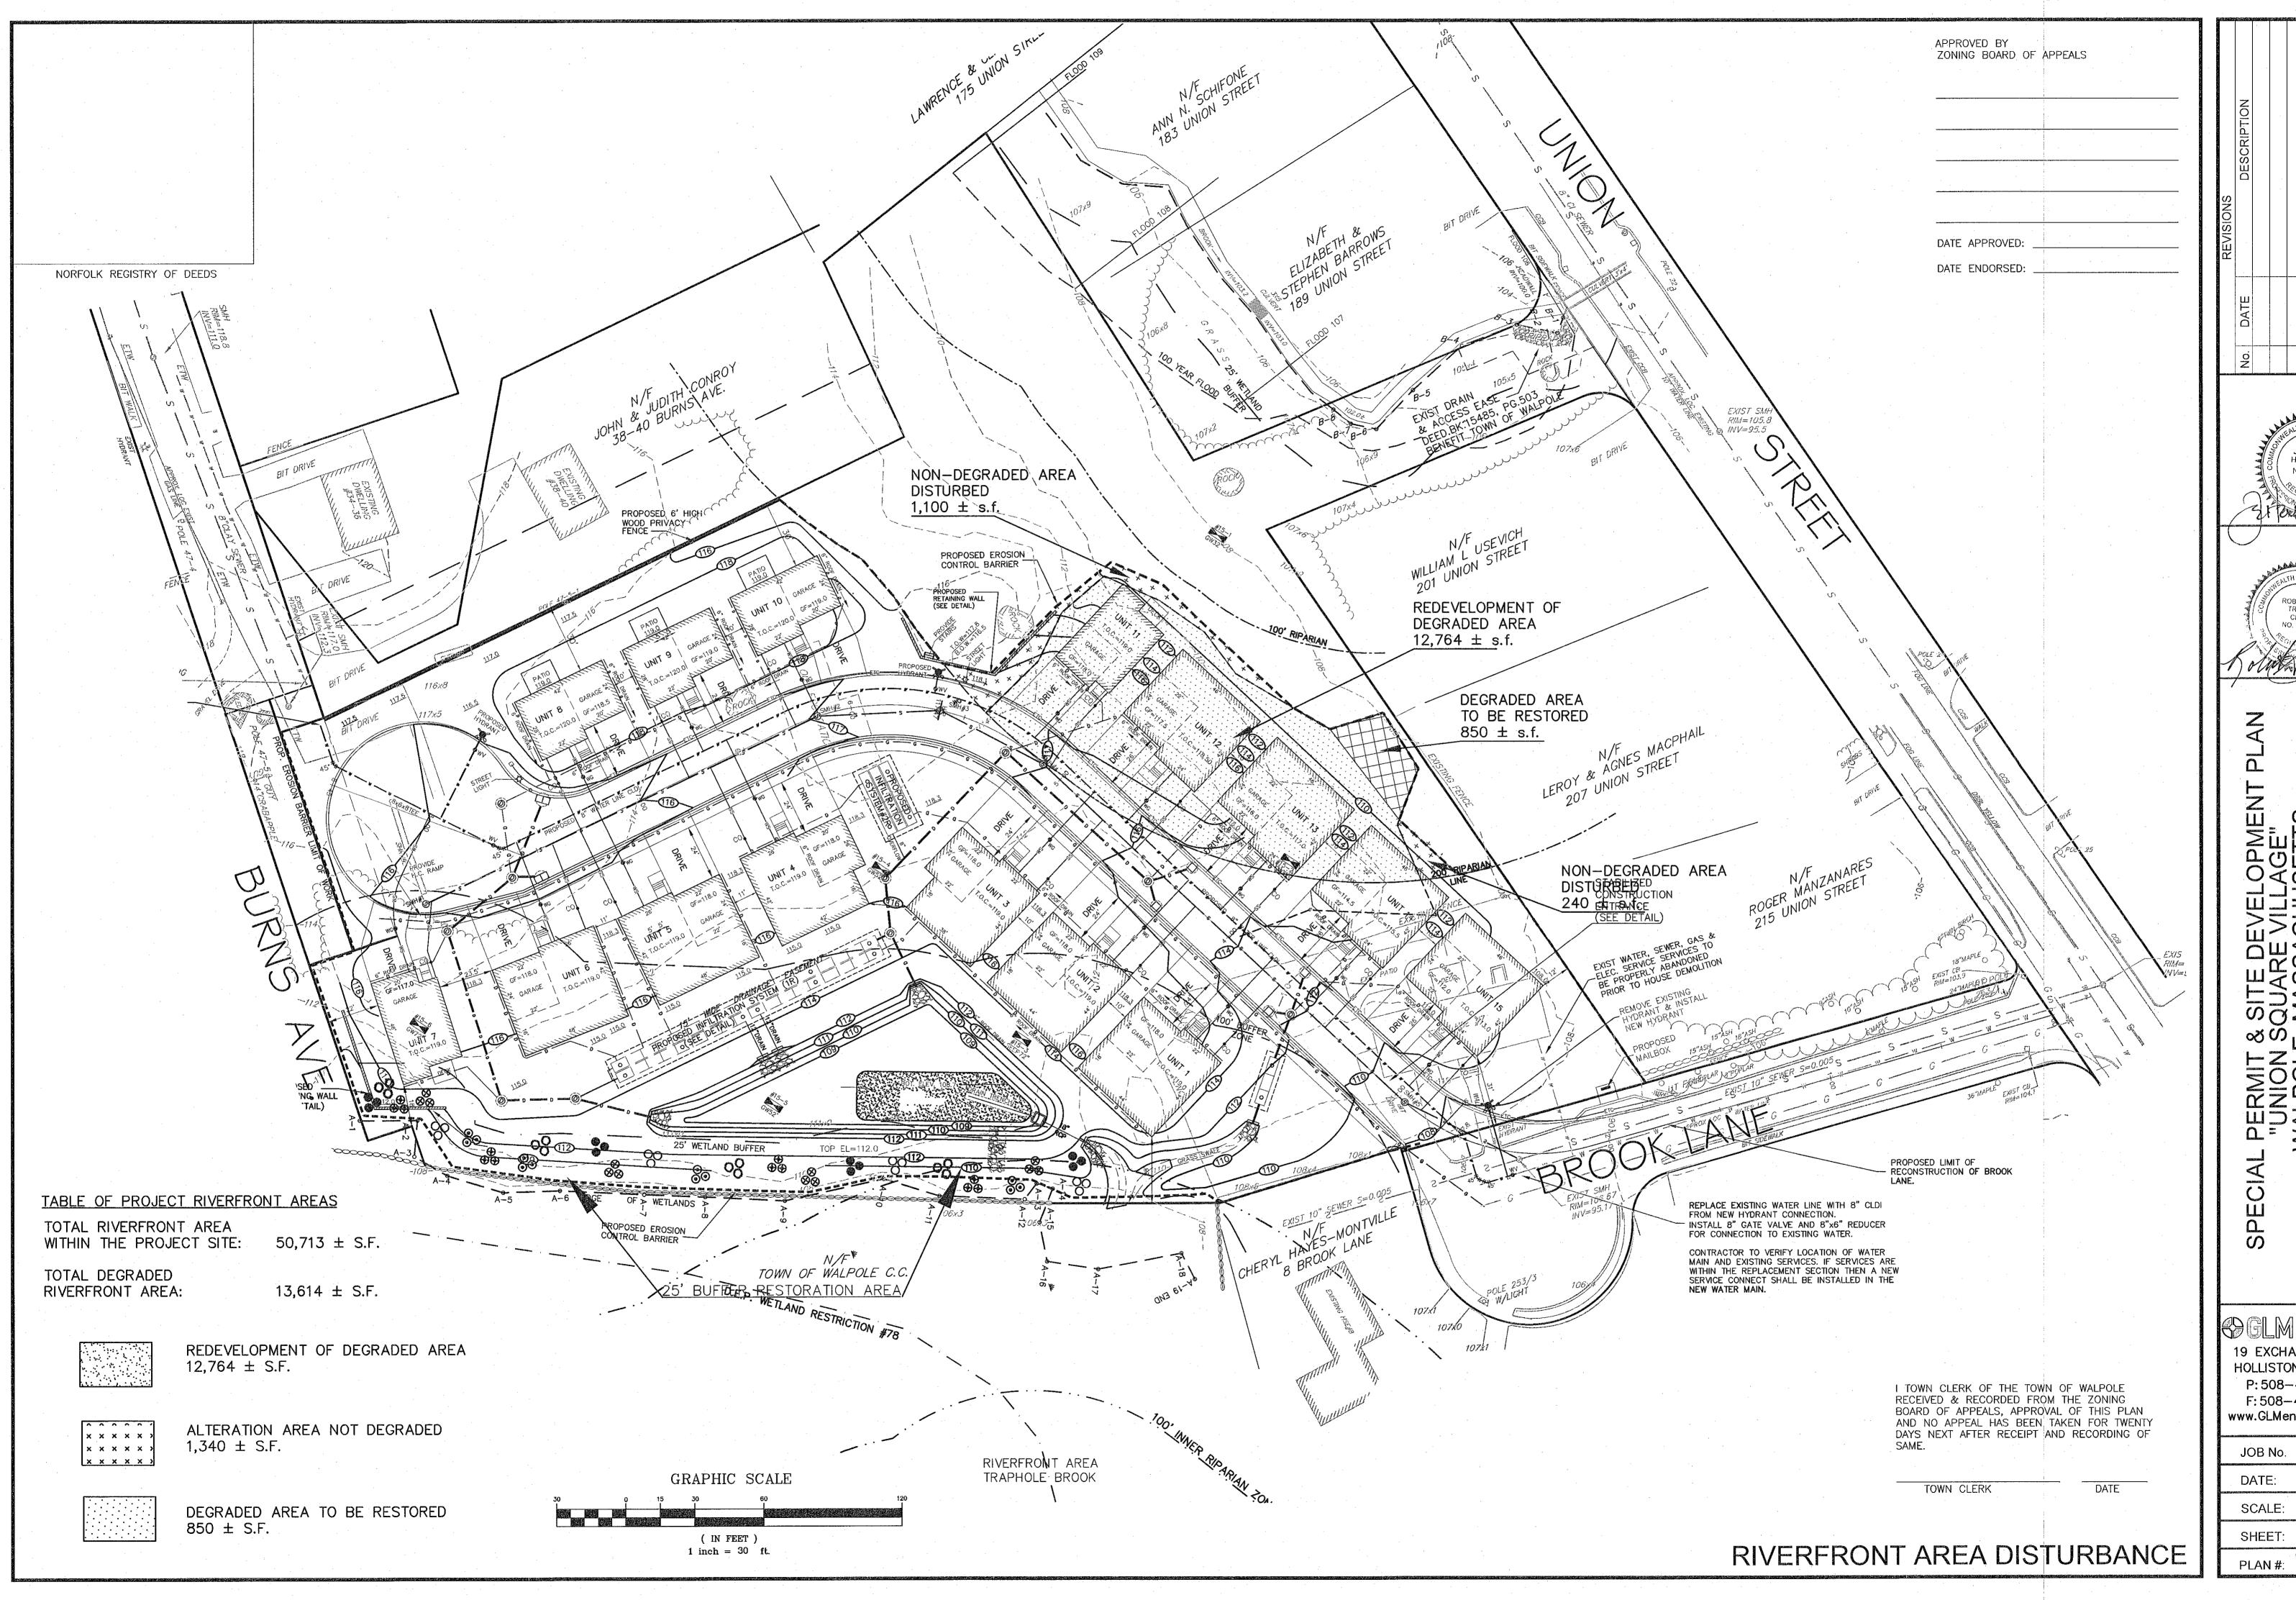

WALPOOL WALPOOL

BULM Engineering Consultants, Inc 19 EXCHANGE STREET HOLLISTON, MA 01746 P: 508-429-1100 F: 508-429-7160 www.GLMengineering.com

> 15,588 JAN. 24, 2024 1"= 30' SUP-B 27,096

